Site Info One Lincoln

## Site Info - One Lincoln

One Lincoln Center 20 West 64<sup>th</sup> Street New York, NY 10023

#### **Site Contact**

Sean Pringle
Project Engineer
Aegis Energy Services Inc.
55 Jackson St Holyoke MA, 01040
413-896-1622
springle@aegisenergyservices.com

• CDH was on site October 1, 2015 to install a datalogger, terminate meter wiring, setup communications, and verify sensor readings. Data collection begins.

## **Summary**

CDH provided the data logger. Aegis provided and installed the gas, power, and BTU meters. Aegis performed all the necessary wire pulls and CDH terminated wiring to the data logger and sensors.

#### **Monitored Data Points**

No.	Input	Data Point	Description	Units	Sensor	Signal
1	MB-001	WB1	Total Facility Power - Main Service 1	kW/kWh	Veris E50C2A	Modbus RS485
2	MB-002	WB2	Total Facility Power - Main Service 3	kW/kWh	Veris E50C2A	Modbus RS485
5	MB-004	WT1	Gross Generator #1 Power	kW/kWh	Veris H8035-300	Modbus RS485
3	MB-003	WT23	Gross Generator #2 & #3 Power	kW/kWh	Veris H8035-300	Modbus RS485
7	MB-006	WP	Parasitic Loads	kW/kWh	Veris H8035-100	Modbus RS485
8	IN1	FG	Generator Gas Use	CF	Romet RM5000 TC	Pulse
10	IN2	THW1	Recovered Heat Loop - Supply Temp.	deg F	MAMAC 10k Type II thermisor	Resistance
11	MB-007	QU	Useful Heat Recovery - BTU Meter Calculated	Mbtu	Badger 380 BTU meter	
12	MB-007	THW2	Recovered Heat Loop - Temp. After Useful HX's	deg F		Modbus RS485
13	MB-007	THW3	Recovered Heat Loop - Return Temp.	deg F		IVIOUDUS K3463
14	MB-007	FHW	Recovered Heat Loop Flow	GPM		

### **IP** Info

IP Address:	24.105.158.218:4081
Subnet Mask:	255.255.255.248
Gateway:	24.105.158.217
Primary DNS:	24.29.99.35
Secondary DNS:	24.29.99.36

Site Info One Lincoln

## **Procedure**

• Power was verified by comparing the cogen unit display to the Veris H8035 modbus reading on the Obvius datalogger.

- Hot water loop flows were verified by comparing the Badger 380 flow reading on the Obvius to measurements taken using a portable Portaflow ultrasonic flowmeter.
- Gas use was verified by checking electrical efficiency and performing a system heat balance using the average gas flow rate as measured by the Obvius datalogger.

## **Verification Data – October 1, 2015**

## Generator Power:

WG1	Cogen Panel - WT1	Obvius - WT1	
WGI	(kW)	(kW)	
	0	1.125	

WT2 & WT3	Cogen Panel - WT2 (kW)	Cogen Panel - WT3 (kW)	Cogen Panels - WT2+WT3 (kW)	Obvius - WT2+WT3 (kW)	
	57	49.3	106.3	99.7	
	55.3	45.5	100.8	99.8	
	51.9	44.1	96	-	

Avg: 101.0 99.8

## Parasitic Loads:

	<b>Extech Handheld</b>	Obvius (kW)	
WP	Power Meter (kW)	Obvius (KW)	
	8.89	9.80	

### Gas:

WT1	WT2&3	WP	FHW	THW1	THW2	QU	FG	Elec. Eff.	Thermal	Total Eff.
(kW)	(kW)	(kW)	(gpm)	(Deg. F)	(Deg. F)	(Mbtu/h)	(cfh)	(%)	Eff. (%)	(%)
1.04	76.3	9.8	54.3	179.5	165.9	360.4	1200	21.3%	29.1%	50.4%

## Flow:

Obvius (gpm)	Portaflow (gpm)
51.41	50.3
51.95	50.1
52.59	49.8
52.94	52.1
54.21	54
54.13	52.8

Avg: 52.9 51.5

Site Info
One Lincoln

## **Site Photos**



Three (3) Aegen Powerverter (PV-75) cogen units located in cogen room in sub-basement level parking garage.



Veris H8035-300 power meter (WT23) located in generator #2 & #3 disconnect in cogen room.



CDH panel containing Obvius data logger and CDH network switch located in cogen room.



Veris H8035-300 power meter (WT3) located in generator #1 disconnect in cogen room.

Site Info
One Lincoln



Recovered heat loop temperature sensor (THW1) located above HX's on load side piping in cogen room.



Romet RM5000 rotary gas meter (FG) with pulse output located in sub-basement parking garage outside cogen room.



Portaflow ultrasonic flowmeter.




Badger 380 BTU meter (FHW, THW2, THW3) located in sub-basement parking garage outside cogen room.


Site Info
One Lincoln





Veris E50C2A power meter, 1 of 2 typ. (WB1, WB2) located in basement electrical motor room (WB1) and 8th floor mechanical room (WB2).

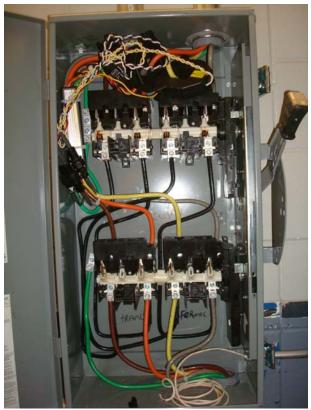

Veris H8035-100 power meter (WP) located in manual transfer switch in basement hallway.

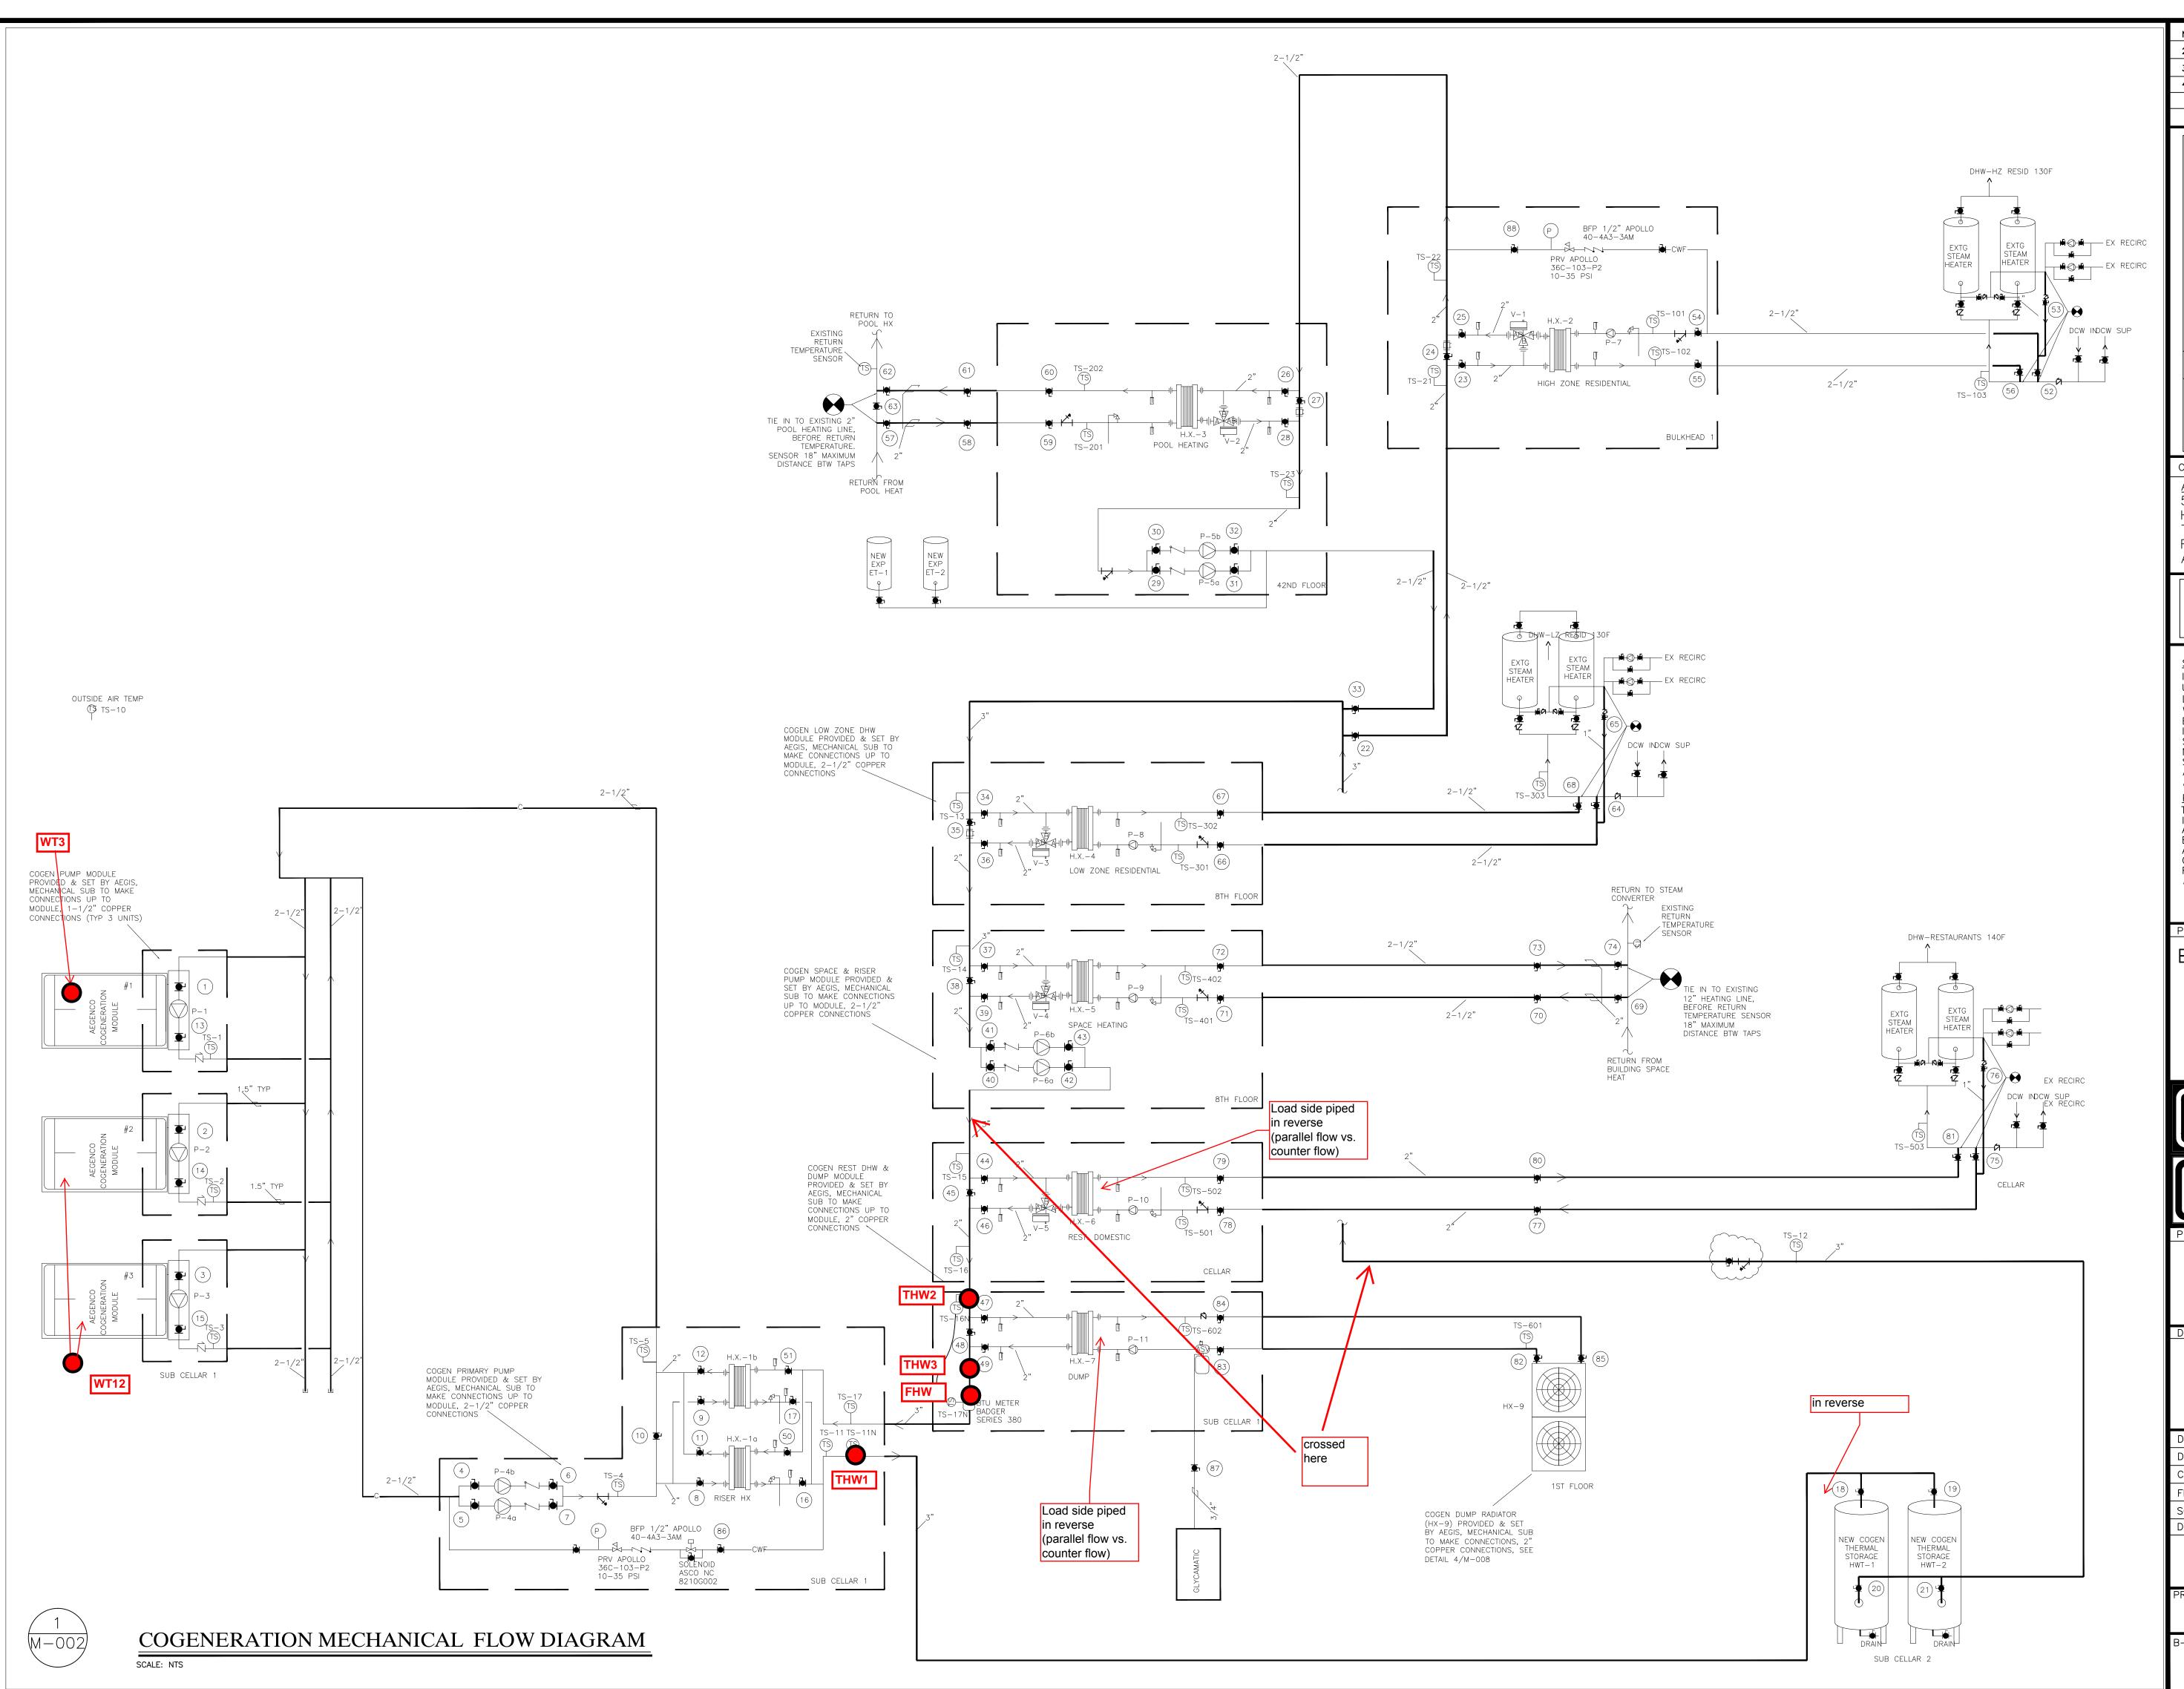

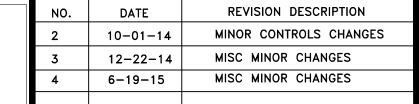

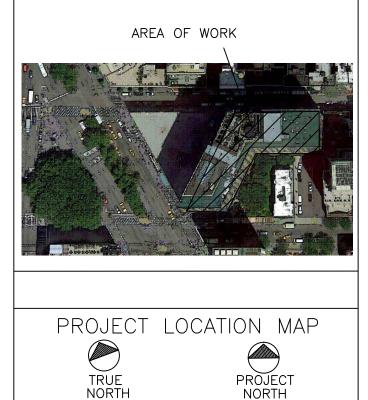

CLIENT:

AEGIS ENERGY SERVICES, INC

55 JACKSON STREET
HOLYOKE, MA 01040
TEL.: 413-536-1156
FAX: 413-536-1104
ATTN: SEAN PRINGLE

ALL DRAWINGS ARE TO BE READ NOT SCALED.

## STATEMENT:

IT IS A VIOLATION OF THE LAW FOR ANY PERSON, UNLESS ACTING UNDER THE DIRECTION OF A LICENSED ENGINEER/ARCHITECT, TO ALTER IN ANY WAY, ANY ITEM ON THESE DRAWINGS. IF AN ITEM BEARING THE SEAL OF AN ENGINEER/ARCHITECT IS ALTERED, THE ALTERING ENGINEER/ARCHITECT SHALL AFFIX TO THIS ITEM THEIR SEAL AND THE NOTATION "ALTERED BY", FOLLOWED BY HIS/HER SIGNATURE AND THE DATE OF SUCH ALTERATION, ALONG WITH A SPECIFIC DESCRIPTION OF THE ALTERATION ON THE DRAWING.


## PROPRIETARY STATEMENT:

THE PLANS AND SPECIFICATIONS HEREIN ARE
INTENDED FOR THE SUBJECT PROJECT ONLY AND
AS A RESULT OF CONTRACTUAL NEGOTIATIONS
BETWEEN BECKER ENGINEERING, PC, THESE PLANS
AND SPECIFICATIONS WILL BE THE SUBJECT OF A
COPYRIGHT PETITION AND MAY NOT BE REVISED OR
REUSED BY ANYONE WITHOUT THE WRITTEN
AUTHORITY OF BECKER ENGINEERING, PC.

PREPARED BY:

## BECKER ENGINEERING, PC

777 SUNRISE HIGHWAY
SUITE 300
LYNBROOK, NY 11563
PHONE: (516) 561-5922
FAX: (516) 823-0219
EMAIL: SUPPORT@BEPC.US
WEB: WWW.BEPC.US

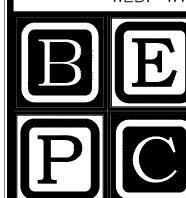

PROJEC

ONE LINCOLN CENTER COGENERATION PROJECT 20 WEST 64TH STREET NEW YORK, NY 10023

DRAWING

# MECHANICAL FLOW DIAGRAM


DESIGN	BY:	SP	DATE:	4/22/14
DRN BY	<b>':</b>	SP	DATE:	6/17/14
CKD BY	<b>':</b>		DATE:	
FINAL C	KD BY:		DATE:	
SCALE:	AS NOT	ED	DATE:	
DWG No	)	P	AGF 4 OF	22

M-002.04

JECT NO.


60 - 091

B-SCAN:

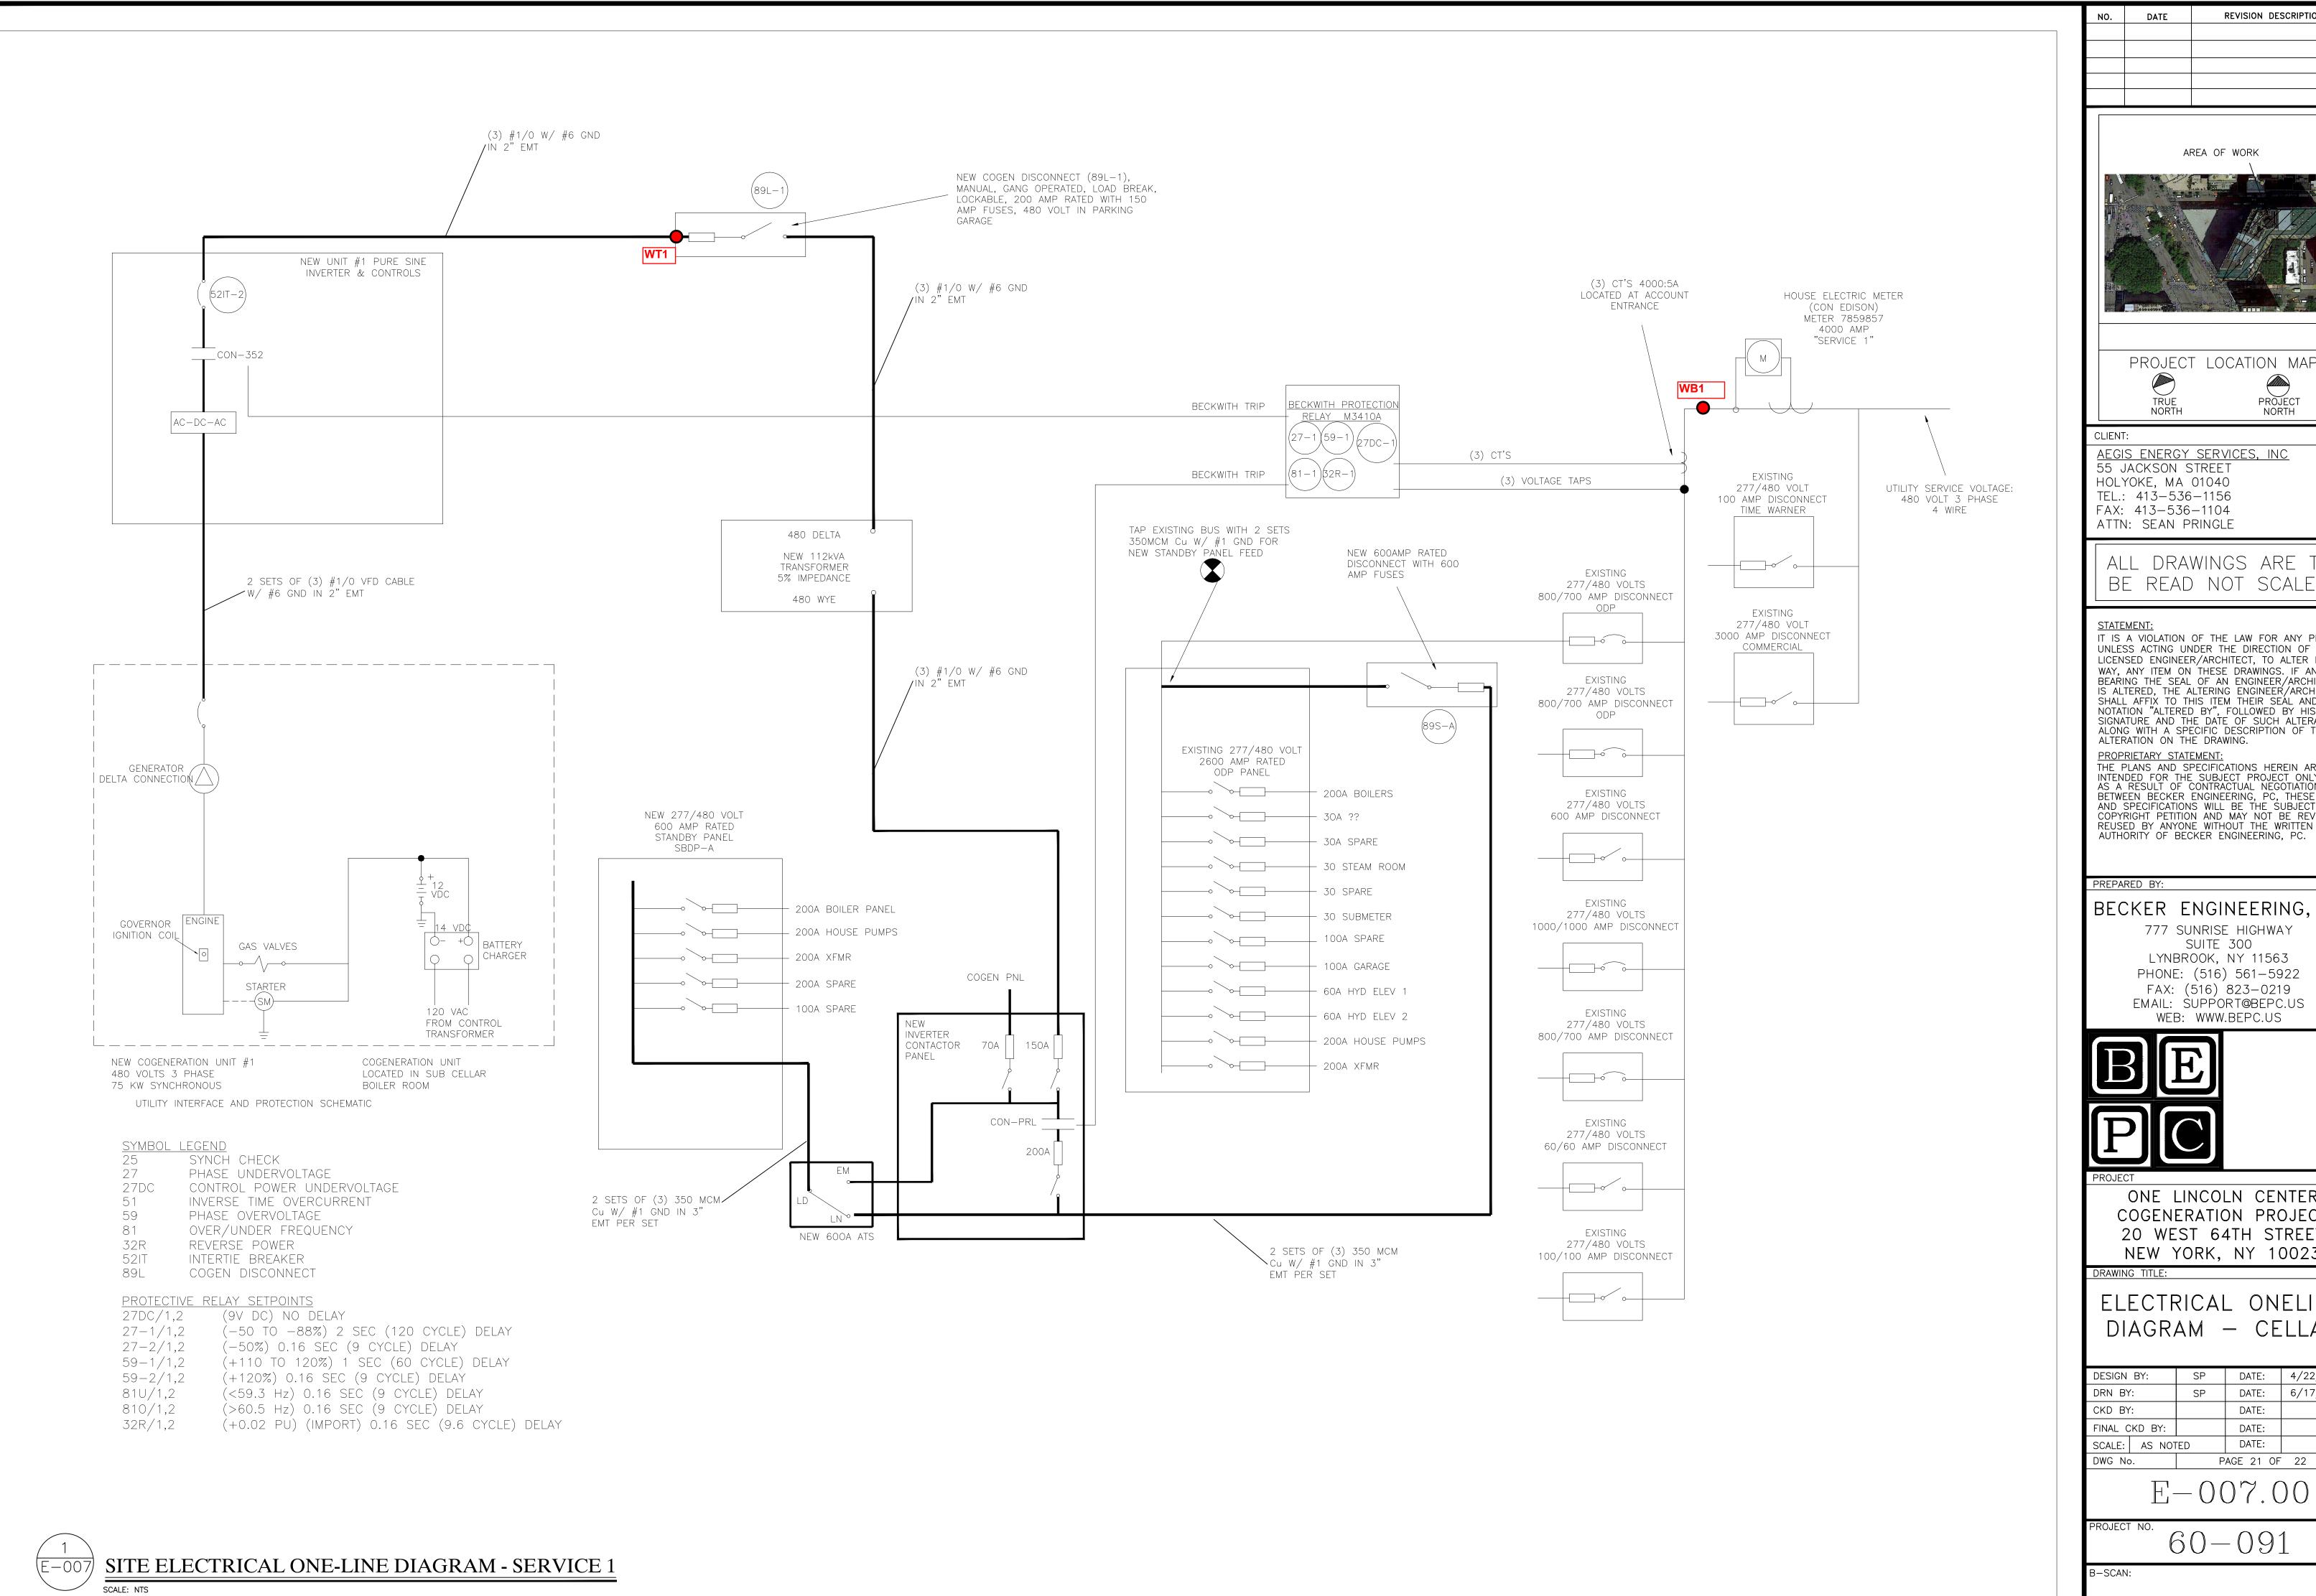

REVISION DESCRIPTION DATE

AREA OF WORK

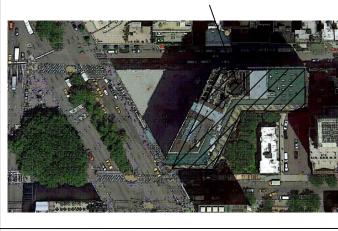

PROJECT LOCATION MAP PROJECT NORTH

AEGIS ENERGY SERVICES, INC. 55 JACKSON STREET HOLYOKE, MA 01040 TEL.: 413-536-1156 FAX: 413-536-1104 ATTN: SEAN PRINGLE


ALL DRAWINGS ARE TO BE READ NOT SCALED

IT IS A VIOLATION OF THE LAW FOR ANY PERSON, UNLESS ACTING UNDER THE DIRECTION OF A LICENSED ENGINEER/ARCHITECT, TO ALTER IN ANY WAY, ANY ITEM ON THESE DRAWINGS. IF AN ITEM BEARING THE SEAL OF AN ENGINEER/ARCHITECT IS ALTERED, THE ALTERING ENGINEER/ARCHITECT SHALL AFFIX TO THIS ITEM THEIR SEAL AND THE NOTATION "ALTERED BY", FOLLOWED BY HIS/HER SIGNATURE AND THE DATE OF SUCH ALTERATION, ALONG WITH A SPECIFIC DESCRIPTION OF THE ALTERATION ON THE DRAWING.

**PROPRIETARY STATEMENT:** THE PLANS AND SPECIFICATIONS HEREIN ARE INTENDED FOR THE SUBJECT PROJECT ONLY AND AS A RESULT OF CONTRACTUAL NEGOTIATIONS BETWEEN BECKER ENGINEERING, PC, THESE PLANS AND SPECIFICATIONS WILL BE THE SUBJECT OF A COPYRIGHT PETITION AND MAY NOT BE REVISED OR

BECKER ENGINEERING, PC

777 SUNRISE HIGHWAY SUITE 300 LYNBROOK, NY 11563 PHONE: (516) 561-5922 FAX: (516) 823-0219 EMAIL: SUPPORT@BEPC.US

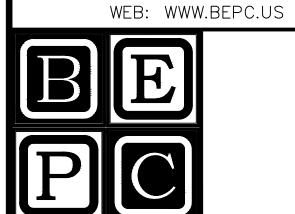


ONE LINCOLN CENTER COGENERATION PROJECT 20 WEST 64TH STREET NEW YORK, NY 10023

ELECTRICAL ONELINE DIAGRAM - CELLAR


DESIGN	BY:	SP	DATE:	4/22/14
DRN BY	<b>':</b>	SP	DATE:	6/17/14
CKD BY	<b>:</b>		DATE:	
FINAL C	KD BY:		DATE:	
SCALE:	AS NOT	TED	DATE:	
DWG No	).	Р	AGE 21 OF	22

E-007.00

60 - 091

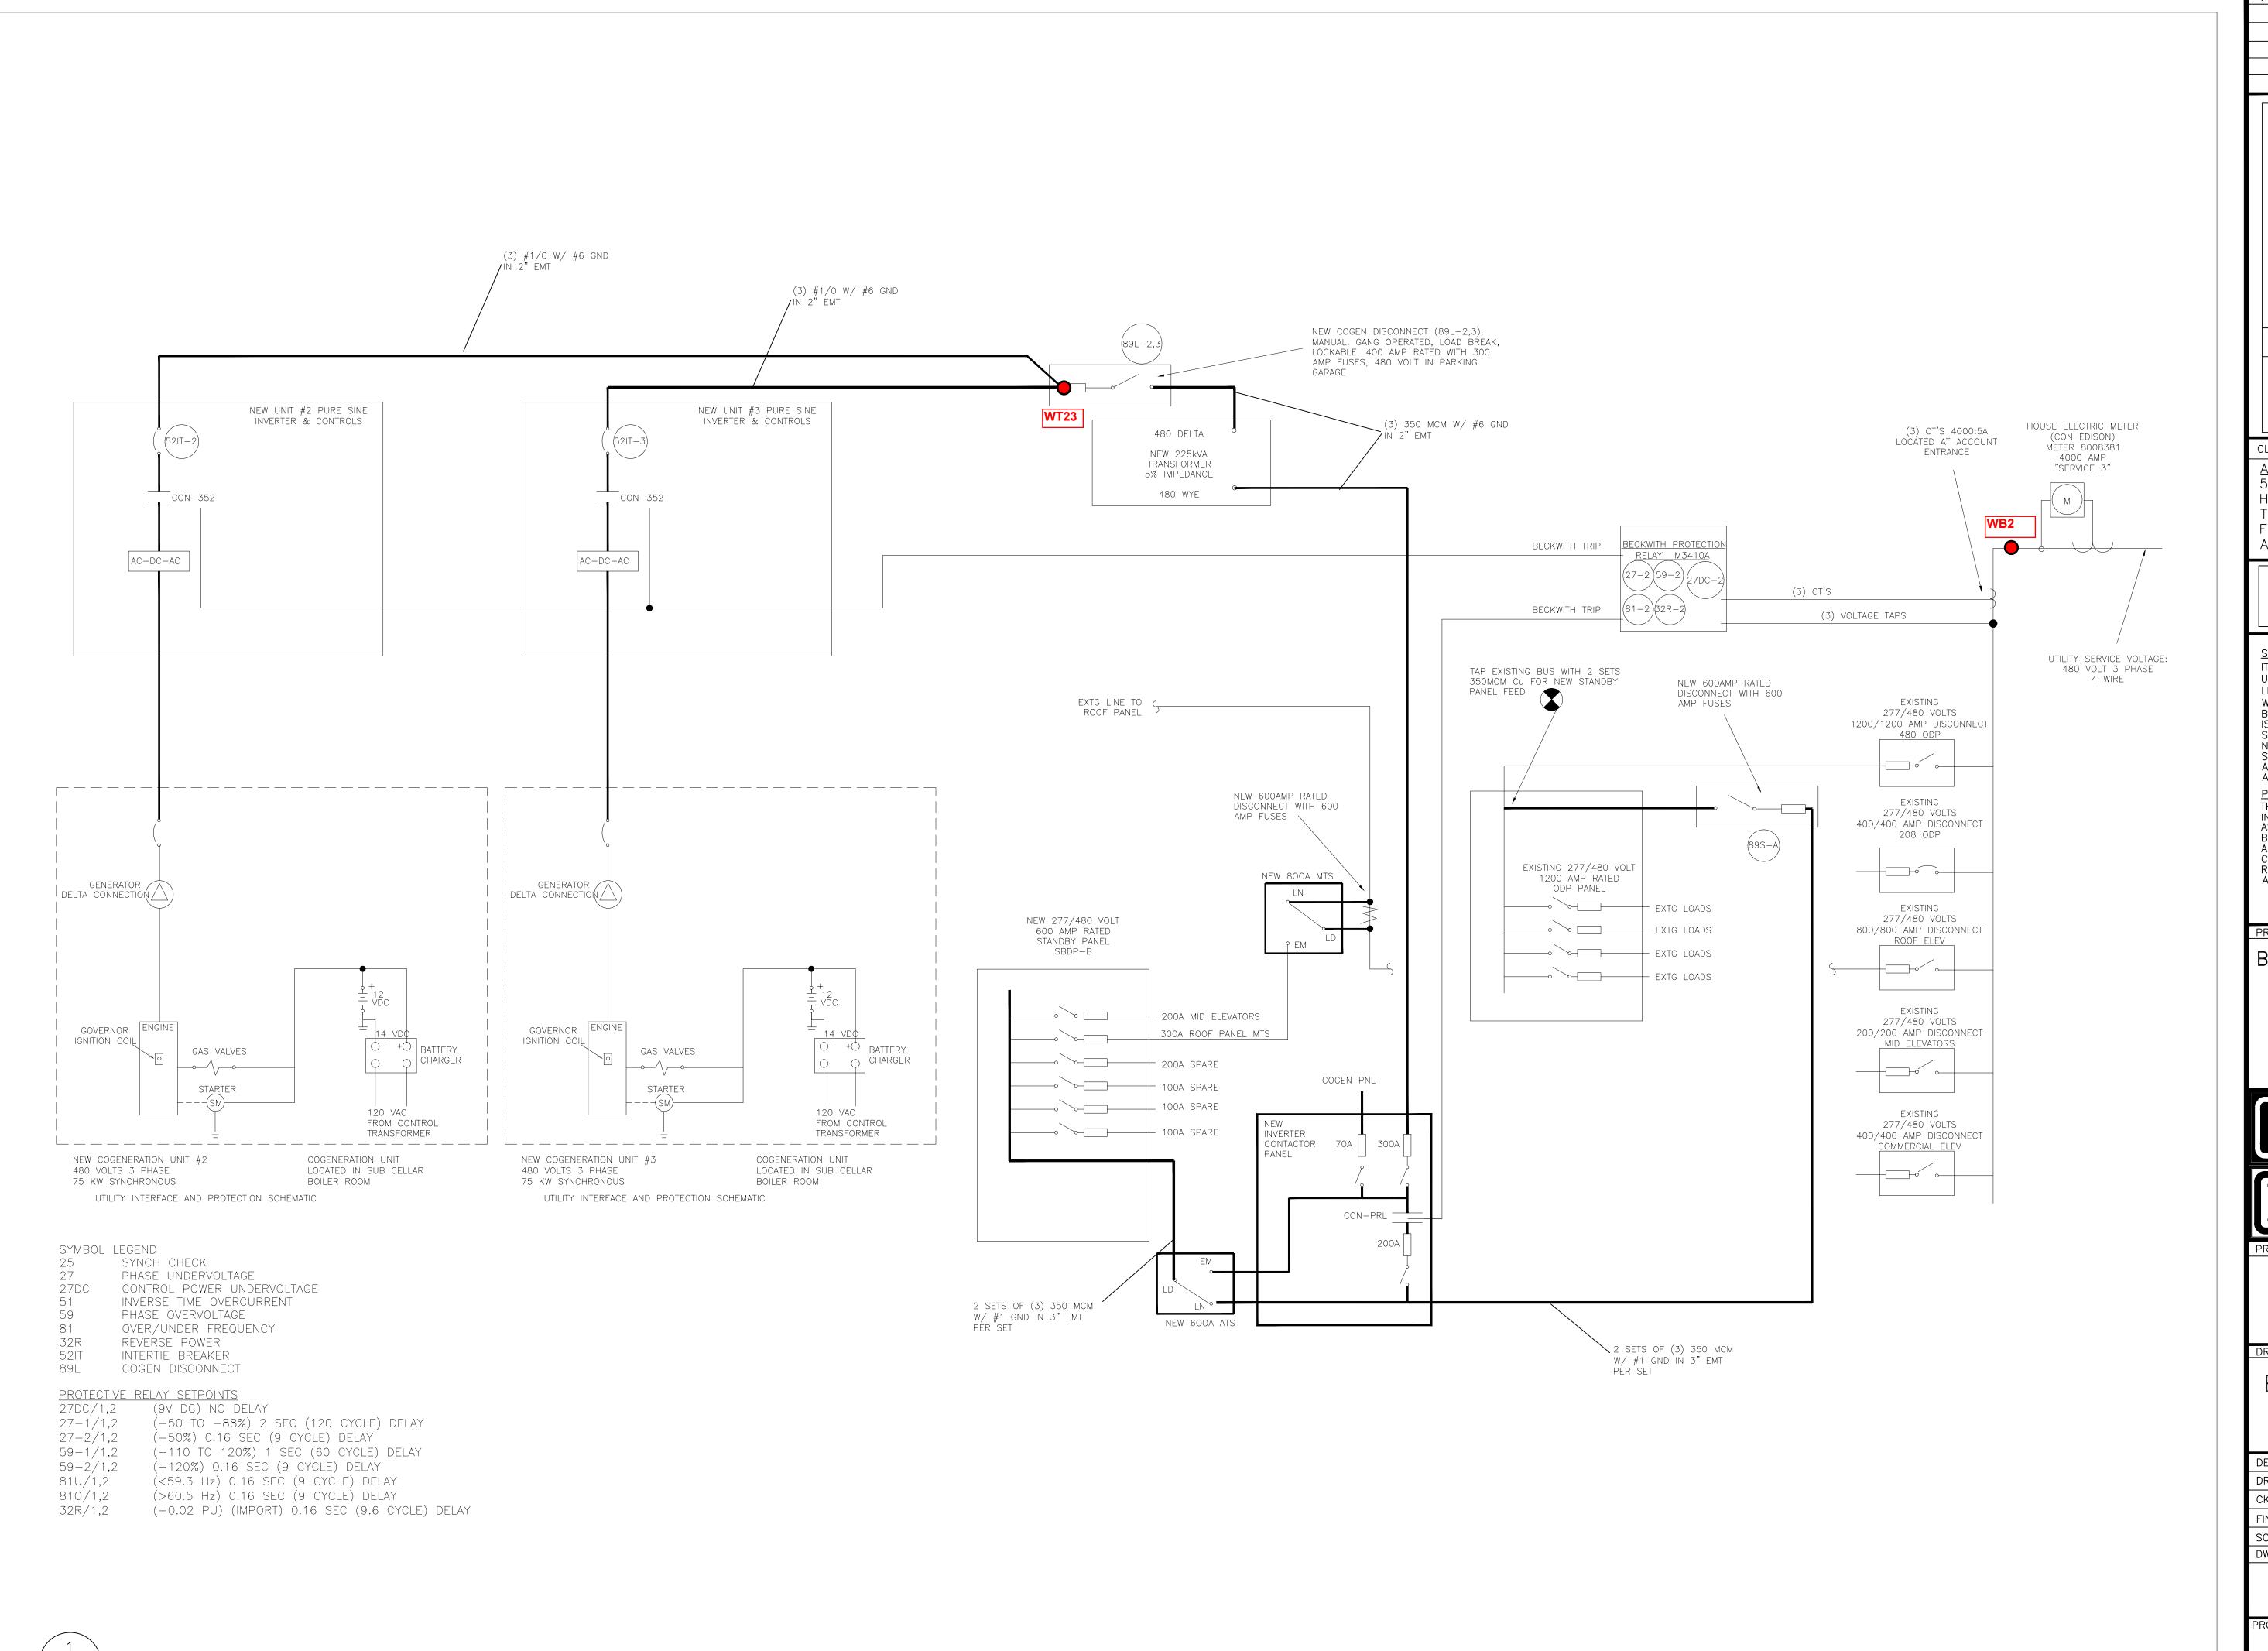

REVISION DESCRIPTION DATE

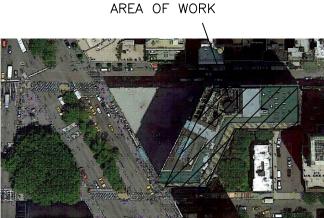

PROJECT LOCATION MAP PROJECT NORTH

CLIENT:

AEGIS ENERGY SERVICES, INC 55 JACKSON STREET HOLYOKE, MA 01040 TEL.: 413-536-1156 FAX: 413-536-1104 ATTN: SEAN PRINGLE

ALL DRAWINGS ARE TO BE READ NOT SCALED

**STATEMENT:** 

IT IS A VIOLATION OF THE LAW FOR ANY PERSON, UNLESS ACTING UNDER THE DIRECTION OF A LICENSED ENGINEER/ARCHITECT, TO ALTER IN ANY WAY, ANY ITEM ON THESE DRAWINGS. IF AN ITEM BEARING THE SEAL OF AN ENGINEER/ARCHITECT IS ALTERED, THE ALTERING ENGINEER/ARCHITECT SHALL AFFIX TO THIS ITEM THEIR SEAL AND THE NOTATION "ALTERED BY", FOLLOWED BY HIS/HER SIGNATURE AND THE DATE OF SUCH ALTERATION, ALONG WITH A SPECIFIC DESCRIPTION OF THE ALTERATION ON THE DRAWING.

**PROPRIETARY STATEMENT:** THE PLANS AND SPECIFICATIONS HEREIN ARE INTENDED FOR THE SUBJECT PROJECT ONLY AND AS A RESULT OF CONTRACTUAL NEGOTIATIONS BETWEEN BECKER ENGINEERING, PC, THESE PLANS AND SPECIFICATIONS WILL BE THE SUBJECT OF A COPYRIGHT PETITION AND MAY NOT BE REVISED OR REUSED BY ANYONE WITHOUT THE WRITTEN AUTHORITY OF BECKER ENGINEERING, PC.

PREPARED BY:

BECKER ENGINEERING, PC 777 SUNRISE HIGHWAY

> SUITE 300 LYNBROOK, NY 11563 PHONE: (516) 561-5922 FAX: (516) 823-0219 EMAIL: SUPPORT@BEPC.US WEB: WWW.BEPC.US



ONE LINCOLN CENTER COGENERATION PROJECT 20 WEST 64TH STREET NEW YORK, NY 10023

ELECTRICAL ONELINE DIAGRAM - 8TH FL

DESIGN	BY:	SP	DATE:	4/22/14
DRN BY	<b>′</b> :	SP	DATE:	6/17/14
CKD BY	<b>'</b> :		DATE:	
FINAL C	KD BY:		DATE:	
SCALE: AS NOT		ΓED	DATE:	
DWG No	).	Р	AGE 22 OF	22

E - 008.00

60 - 091

B-SCAN:

E-008 SITE ELECTRICAL ONE-LINE DIAGRAM - SERVICE 3 SCALE: NTS