
PLAZA RESIDENCES 37 NEW LOTS AVE COGENERATION SYSTEM

DRAWING INDEX: SHEET NO. TITLE OF DRAWING

- TITLE SHEET, GENERAL NOTES & MECHANICAL SYMBOL LIST T-101.00
- G-101.00 ENERGY ANALYSIS
- MECHANICAL SCHEDULES & FLOW DIAGRAM M - 101.00CELLAR MECHANICAL HVAC/PIPING LAYOUT M-201.00
- MECHANICAL/HVAC DETAILS M - 301.00
- CELLAR PLUMBING/GAS LAYOUT P-101.00 P-201.00 GAS RISER DIAGRAM & PLUMBING DETAILS
- CELLAR ELECTRICAL LAYOUT E-101.00 E-201.00 COGENERATION ELECTRICAL ONE LINE DIAGRAM

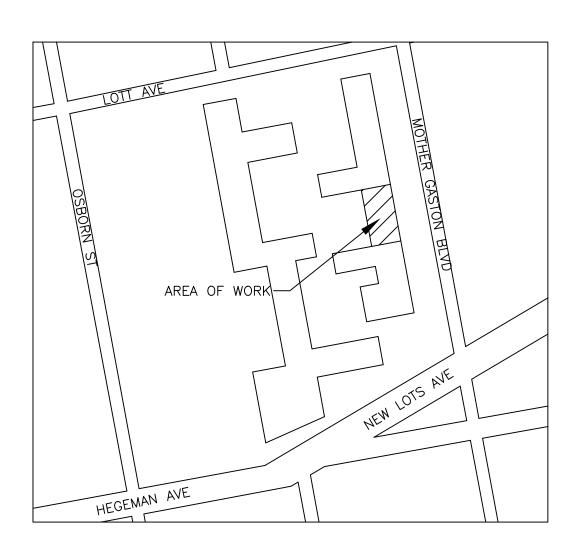

REVIEWER NOTE:

THE SCOPE OF WORK FOR THIS PROJECT INCLUDES THE INSTALLATION OF TWO (2) 35KW MODULAR COGENERATION MODULES TO GENERATE HEAT AND ELECTRICITY FOR PLAZA RESIDENCES, 37 NEW LOTS AVE, NEW YORK, NEW YORK, 11212

ADDRESS: 37 NEW LOTS AVE BIN: 332660' <u> 3628 BLOCK:</u> <u># BUILDINGS:</u> # FLOORS: 6 & 1 BELOW GRADE ROSS AREA: 245,538 DWELLING UNITS: 385 YEAR OF CONSTRUCTION: 1969

NOIE:

- DRAWINGS ARE TO BE READ, NOT SCALED. ALL WORK SHALL CONFORM TO THE 2016 NEW YORK CITY BUILDING CODE. TO THE BEST OF OUR KNOWLEDGE, BELIEF, AND PROFESSIONAL JUDGMENT, SUCH PLANS AND SPECIFICATIONS ARE IN CONFORMANCE WITH THE 2016 NYC ENERGY CONSERVATION CONSTRUCTION CODE. PIPING HAVE BEEN SPECIFIED TO BE INSULATED WITH R-3 INSULATION, DOMESTIC HOT WATER STORAGE TANKS HAVE R-13 INSULATION AND COGENERATION MODULE MEETS EFFICIENCY REQUIREMENTS. SEE ENERGY ANALYSIS ON SHEET G-1.
- ALL CONDITIONS ARE EXISTING EXCEPT AS NOTED. THESE PLANS ARE APPROVED ONLY FOR THE WORK INDICATED ON THE APPLICATION SPECIFICATION SHEET. ALL OTHER MATTERS SHOWN ARE NOT TO BE RELIED UPON OR TO BE CONSIDERED EITHER APPROVED OR IN ACCORDANCE WITH APPLICABLE CODE. NO CHANGE IN USE, EGRESS OR OCCUPANCY.

SPECIAL/PROGRESS INSPECTIO THE FOLLOWING ITEMS OF WORK SHALL BE SUBJECT INSPECTION, MADE AND WITNESSED BY OR UNDER THE ARCHITECT OR ENGINEER RETAINED BY THE CONTRACT PERFORM SUCH INSPECTIONS. A TEST REPORT AND FILED WITH THE BUILDING DEPARTMENT.

MECHANICAL SYSTEMS HEATING SYSTEMS FIRESTOP, DRAFTSTOP & FIREBLOCK – BC 1704.25

(BLOCK 3628, LOT 1)

GENERAL NOTES:

- CONTRACTOR TO VERIFY ALL DIMENSIONS IN FIELD PRIOR TO CONSTRUCTION, AND REPORT TO ENGINEER ALL ERRORS, DISCREPANCIES, OMISSIONS, DEFECTS, OR UNUSUAL WORK CONDITIONS BEFORE COMMENCING CONSTRUCTION.
- 2. ALL WORK IS TO BE PERFORMED IN ACCORDANCE WITH THE APPLICABLE RULES AND REGULATIONS OF ALL GOVERNING AGENCIES INCLUDING BUT NOT LIMITED TO THE CODES AND REGULATIONS AS SET FORTH BY THE CITY OF NEW YORK AND STATE OF NEW YORK.
- 3. CONTRACTOR TO SECURE ALL NECESSARY PERMITS REQUIRED FOR THE STIPULATED WORK PRIOR TO COMMENCING WITH CONSTRUCTION OR DEMOLITION.
- 4. ALL ASBESTOS REMOVAL, PLUMBING, ELECTRICAL, WELDING WORK, ETC. TO BE PERFORMED BY LICENSED CONTRACTORS SUBCONTRACTED BY AEGIS ENERGY SERVICES.
- 5. ALL CONTRACTORS, WORKMEN, AND AGENTS WORKING AT OR VISITING THE SITE SHALL BE COVERED BY ALL
- NECESSARY STATUTORY INSURANCE INCLUDING LIABILITY, WORKMEN'S COMPENSATION, DISABILITY, ETC. 6. ALL WORK SHALL BE PERFORMED IN A NEAT, CLEAN, ORDERLY MANNER AND THE SITE KEPT CLEAN FROM DUST AND DEBRIS AT ALL TIMES.
- 7. CONTRACTORS TO PROVIDE ALL NECESSARY TEMPORARY LIGHTING, POWER, WATER, WATERPROOFING, ETC. NEEDED TO ENSURE PROJECT SAFETY AT ALL TIMES.
- 8. CONTRACTORS TO PROVIDE ALL NECESSARY SHORING, BRIDGING, BARRICADES, SIGNS, ETC. NEEDED TO ENSURE PROJECT SAFETY AT ALL TIMES.
- 9. ALL WORK, INCLUDING TESTING AND TEMPORARY SHUT DOWN OF SERVICES IS TO BE COORDINATED WITH OWNER'S SCHEDULE FOR DELIVERIES, WORKDAYS, TIMES, ETC.
- 10. ALL NEW WORK TO BE THOROUGHLY TIED AND BONDED TO EXISTING WORK
- 11. ALL PATCHING AND JOINING SHALL BE NEAT, CLEAN, AND SQUARE, MATCHING ADJACENT SURFACES IN FINISH AND TEXTURE.
- 12. ALL FIRE RETARDANT MATERIALS SHALL BEAR STAMPS, SEALS, AND/OR PERMANENT LABELS AS REQUIRED. AFFIDAVITS SHALL BE PROVIDED WHEN REQUESTED.
- 13. ALL WORK TO BE PLUMB, LEVEL, AND TO THE BEST OF WORKMANSHIP
- 14. CONTRACTOR TO FULLY COORDINATE HIS WORK AND EFFORTS WITH OTHER TRADES TO ENSURE A NEAT, PROPER. DIMENSIONALLY ACCURATE JOB IN ALL RESPECTS TO RELATED WORK.
- 15. THE JOB SHALL BE ADEQUATELY STAFFED AT ALL TIMES TO ENSURE CONTINUITY AND PROGRESS, WITH ALL PHASES/SEGMENTS OF WORK PROPERLY COORDINATED.
- 16. ALL DEFECTIVE OR UNACCEPTABLE WORK SHALL BE REMOVED AND REPLACED, INCLUDING ANY SURROUNDING AFFECTED AREAS, AT NO ADDITIONAL COST TO THE OWNER.
- 17. CONTRACTOR TO SUBMIT SHOP DRAWINGS AND SAMPLES FOR ENGINEER'S APPROVAL WHERE REQUIRED BY DOCUMENTS PRIOR TO PROCEEDING WITH WORK
- 18. ALL WORK, UNLESS OTHERWISE SPECIFIED, TO BE GUARANTEED FOR A MINIMUM OF ONE YEAR FROM FINAL ACCEPTANCE.
- 19. ANY MATERIAL COMPOSITION WHICH IS QUESTIONABLE SHALL BE BROUGHT TO THE ATTENTION OF THE ENGINEER.
- THE DETERMINATION OF THE ACCEPTABILITY OF ALL MATERIALS SHALL BE AT THE SOLE DISCRETION OF THE ENGINEER. 20. ANY CONFLICT BETWEEN THE SPECIFICATIONS AND DRAWINGS IS TO BE BROUGHT TO THE ATTENTION OF THE ENGINEER PRIOR TO WORK.
- 21. ALL PIPES TO BE INSULATED WITH 1" HEAVY DENSITY FIBERGLASS INSULATION WITH ALL SURFACE JACKET.
- 22. ALL PIPING TO BE HARD COPPER "L" GRADE UNLESS OTHERWISE SPECIFIED.

TENANT PROTECTION PLAN:

- 1. THE BUILDING CONTAINS SPACES WHICH WILL BE OCCUPIED DURING CONSTRUCTION.
- EGRESS: DURING THE COURSE OF CONSTRUCTION EGRESS FROM ALL FLOORS SHALL BE MAINTAINED AT ALL TIMES. 2.
- 3. FIRE SAFETY: ALL REQUIRED PRECAUTIONS WILL BE TAKEN TO PROVIDE FIRE SAFETY DURING CONSTRUCTION.
- HEALTH REQUIREMENTS: DUST SHALL BE KEPT AT A MINIMUM AND SHALL BE REMOVED AT THE END OF EACH WORKING DAY. CONSTRUCTION DEBRIS SHALL BE DISPOSED IN A SAFE MANNER. CONSTRUCTION NOISE WILL BE CEASED AFTER NORMAL WORKING HOURS. NOISE SHALL BE LIMITED TO ACCEPTABLE LIMITS. SANITARY FACILITIES SHALL BE PROVIDED AT ALL TIMES. PEST CONTROL SHALL BE PROVIDED AT ALL TIMES DURING THE COURSE OF CONSTRUCTION.
- THE CONTRACTOR SHALL COMPLY WITH APPLICABLE LAWS RELATING TO LEAD AND ASBESTOS. IN CASE LEAD OR ASBESTOS ARE FOUND THE OWNER OR ENGINEER SHALL BE INFORMED IMMEDIATELY.
- ELECTRICAL, GAS OR OTHER UTILITIES SHALL NOT BE INTERRUPTED DURING CONSTRUCTION. CONTRACTOR OR OWNER SHALL NOTIFY THE TENANT IN WRITING BEFORE ANY INTERRUPTION OF SERVICES IS PERFORMED.
- 7. BUILDING SECURITY SHALL BE MAINTAINED TO PREVENT UNAUTHORIZED PERSONS FROM ENTERING THE BUILDING.
- FLOORS SHALL NOT BE OVERLOADED BEYOND PERMISSIBLE LIMITS. 8.
- NO STRUCTURAL WORK SHALL BE PERFORMED WHICH MAY ENDANGER THE OCCUPANTS. 9.
- 10. CONSTRUCTION OPERATION SHALL BE CONFINED TO NORMAL WORKING HOURS: 8:00 A.M. THROUGH 5:00 P.M. MONDAY THROUGH FRIDAY, EXCEPT LEGAL HOLIDAYS, UNLESS AUTHORIZED IN WRITING BY OWNERS.

N REQUIREMENTS:
TO SPECIAL AND/OR PROGRESS
DIRECT SUPERVISION OF AN
CERTIFICATE OF INSPECTION SHALL BE

– BC 1704.15

– BC 1704.23

SPECIAL INSPECTIONS/PROGRESS (TR-1)

- MECHANICAL SYSTEMS
- HEATING SYSTEMS
- FIRE-RESISTANT PENETRATIONS AND JOINTS
- ☑ ENERGY CODE COMPLIANCE INSPECTION

ENERGY CODE COMPLIANCE INSPECTIONS (TR-8)


- HVAC & SERVICE WATER HEATING EQUIPMENT
- HVAC & SERVICE WATER HEATING CONTROLS
- DUCT PLENUM AND PIPING INSULATION & SEALING
- MAINTENANCE INFORMATION
- BC 1704.16 BC 1704.27
- BC 1704.25
- BC 110.3.5

			AREA OF WORK
	\frown		AEGIS ENERGY SERVICES, INC
ME(<u>NCAL SYMBOLS LIST:</u>	55 JACKSON STREET
	(M)	METER	HOLYOKE, MA 01040 TEL.: 413-536-1156
	\bigcirc	CIRCULATION PUMP	FAX: 413-536-1104
	TS	TEMPERATURE SENSOR	ATTN: KEVIN MAY
		BALL VALVE	
			ALL DRAWINGS ARE TO
	ф	BUTTERFLY VALVE	BE READ NOT SCALED.
	 ⊡	UNION	STATEMENT
		THERMOMETER	STATEMENT: IT IS A VIOLATION OF THE LAW FOR ANY PERSON,
	Å	PRESSURE RELIEF VALVE	UNLESS ACTING UNDER THE DIRECTION OF A LICENSED ENGINEER/ARCHITECT, TO ALTER IN ANY
		AQUASTAT	WAY, ANY ITEM ON THESE DRAWINGS. IF AN ITEM BEARING THE SEAL OF AN ENGINEER/ARCHITECT
	K →I	STRAINER – Y TYPE	IS ALTERED, THE ALTERING ENGINEER/ARCHITECT SHALL AFFIX TO THIS ITEM THEIR SEAL AND THE
	MAVA	MANUAL AIR VENT	NOTATION "ALTERED BY", FOLLOWED BY HIS/HER SIGNATURE AND THE DATE OF SUCH ALTERATION,
	·		ALONG WITH A SPECIFIC DESCRIPTION OF THE ALTERATION ON THE DRAWING.
-	<u> </u>	FLOW DIRECTION	PROPRIETARY STATEMENT: THE PLANS AND SPECIFICATIONS HEREIN ARE
	TS 	COGEN TEMPERATURE SENSOR	INTENDED FOR THE SUBJECT PROJECT ONLY AND AS A RESULT OF CONTRACTUAL NEGOTIATIONS
-		GATE VALVE	BETWEEN BECKER ENGINEERING, PC, THESE PLANS AND SPECIFICATIONS WILL BE THE SUBJECT OF A
-		CHECK VALVE	COPYRIGHT PETITION AND MAY NOT BE REVISED OR REUSED BY ANYONE WITHOUT THE WRITTEN
-	-7-	FLOW CHECK	AUTHORITY OF BECKER ENGINEERING, PC.
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	<u> </u>		BECKER ENGINEERING, PC
			BECKER ENGINEERING, PC 777 SUNRISE HIGHWAY, SUITE 300
		HEAT EXCHANGER	777 SUNRISE HIGHWAY, SUITE 300 Lynbrook, ny 11563
			777 SUNRISE HIGHWAY, SUITE 300 LYNBROOK, NY 11563 PHONE: (516) 561–5922
			777 SUNRISE HIGHWAY, SUITE 300 LYNBROOK, NY 11563 PHONE: (516) 561–5922 FAX: (516) 823–0219 EMAIL: SUPPORT@BEPC.US
		HEAT EXCHANGER 3-WAY VALVE	777 SUNRISE HIGHWAY, SUITE 300 LYNBROOK, NY 11563 PHONE: (516) 561–5922 FAX: (516) 823–0219 EMAIL:
		HEAT EXCHANGER 3-WAY VALVE A: NORMALLY CLOSED B: NORMALLY OPEN	777 SUNRISE HIGHWAY, SUITE 300 LYNBROOK, NY 11563 PHONE: (516) 561–5922 FAX: (516) 823–0219 EMAIL: SUPPORT@BEPC.US
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IIB3 IIB4	N.O. N.C. C.W. C.S. C.S	HEAT EXCHANGER 3-WAY VALVE A: NORMALLY CLOSED B: NORMALLY OPEN AB: MIXED WATER NORMALLY OPEN/ON NORMALLY OPEN/ON NORMALLY CLOSED/OFF CLOSED WINTER CLOSED SUMMER POINT OF CONNECTION TO EXISTING COLD WATER (DOMESTIC) COLD WATER FILL BUILDING HEAT SUPPLY BUILDING HEAT RETURN BUILDING DHW RETURN BUILDING DHW CIRCULATION COGEN PROCESS LOOP PIPING COGEN DHW SUPPLY GLYCOL SUPPLY GLYCOL RETURN COGEN EXHAUST PIPE	777 SUNRISE HIGHWAY, SUITE 300 LYNBROOK, NY 11563 PHONE: (516) 561–5922 FAX: (516) 823–0219 EMAIL: SUPPORT@BEPC.US WEB: WWW.BEPC.US PROJECT PLAZA RESIDENCES COGENERATION PROJECT 37 NEW LOTS AVE BROOKLYN, NY 11212 DRAWING TITLE: TITLE SHEET, GENERAL NOTES & MECHANICAL SYMBOL LIST DESIGN BY: KM DATE: 10/20/16 DRN BY: KM DATE: 10/20/16 CKD BY: DATE: . FINAL CKD BY: DATE: . SCALE: AS NOTED DATE: . DWG NO. PAGE 1 OF 9 T—OO1.00 PROJECT NO. 60—336
IIB3 IIB4 IIB5	N.O. N.C. C.W. C.S. C.S	HEAT EXCHANGER 3-WAY VALVE A: NORMALLY CLOSED B: NORMALLY OPEN AB: MIXED WATER NORMALLY OPEN/ON NORMALLY OPEN/ON NORMALLY CLOSED/OFF CLOSED WINTER CLOSED SUMMER POINT OF CONNECTION TO EXISTING COLD WATER (DOMESTIC) COLD WATER FILL BUILDING HEAT SUPPLY BUILDING HEAT RETURN BUILDING DHW RETURN BUILDING DHW CIRCULATION COGEN PROCESS LOOP PIPING COGEN DHW SUPPLY GLYCOL SUPPLY GLYCOL RETURN COGEN EXHAUST PIPE	777 SUNRISE HIGHWAY, SUITE 300 LYNBROOK, NY 11563 PHONE: (516) 561–5922 FAX: (516) 823–0219 EMAIL: SUPPORT@BEPC.US WEB: WWW.BEPC.US PROJECT PLAZA RESIDENCES COGENERATION PROJECT 37 NEW LOTS AVE BROOKLYN, NY 11212 DRAWING TITLE: TITLE SHEET, GENERAL NOTES & MECHANICAL SYMBOL LIST DESIGN BY: KM DATE: 10/20/16 DRN BY: KM DATE: 10/20/16 CKD BY: DATE: . FINAL CKD BY: DATE: . SCALE: AS NOTED DATE: . DWG NO. PAGE 1 OF 9 T—OO1.00

DATE

NO.

REVISION DESCRIPTION

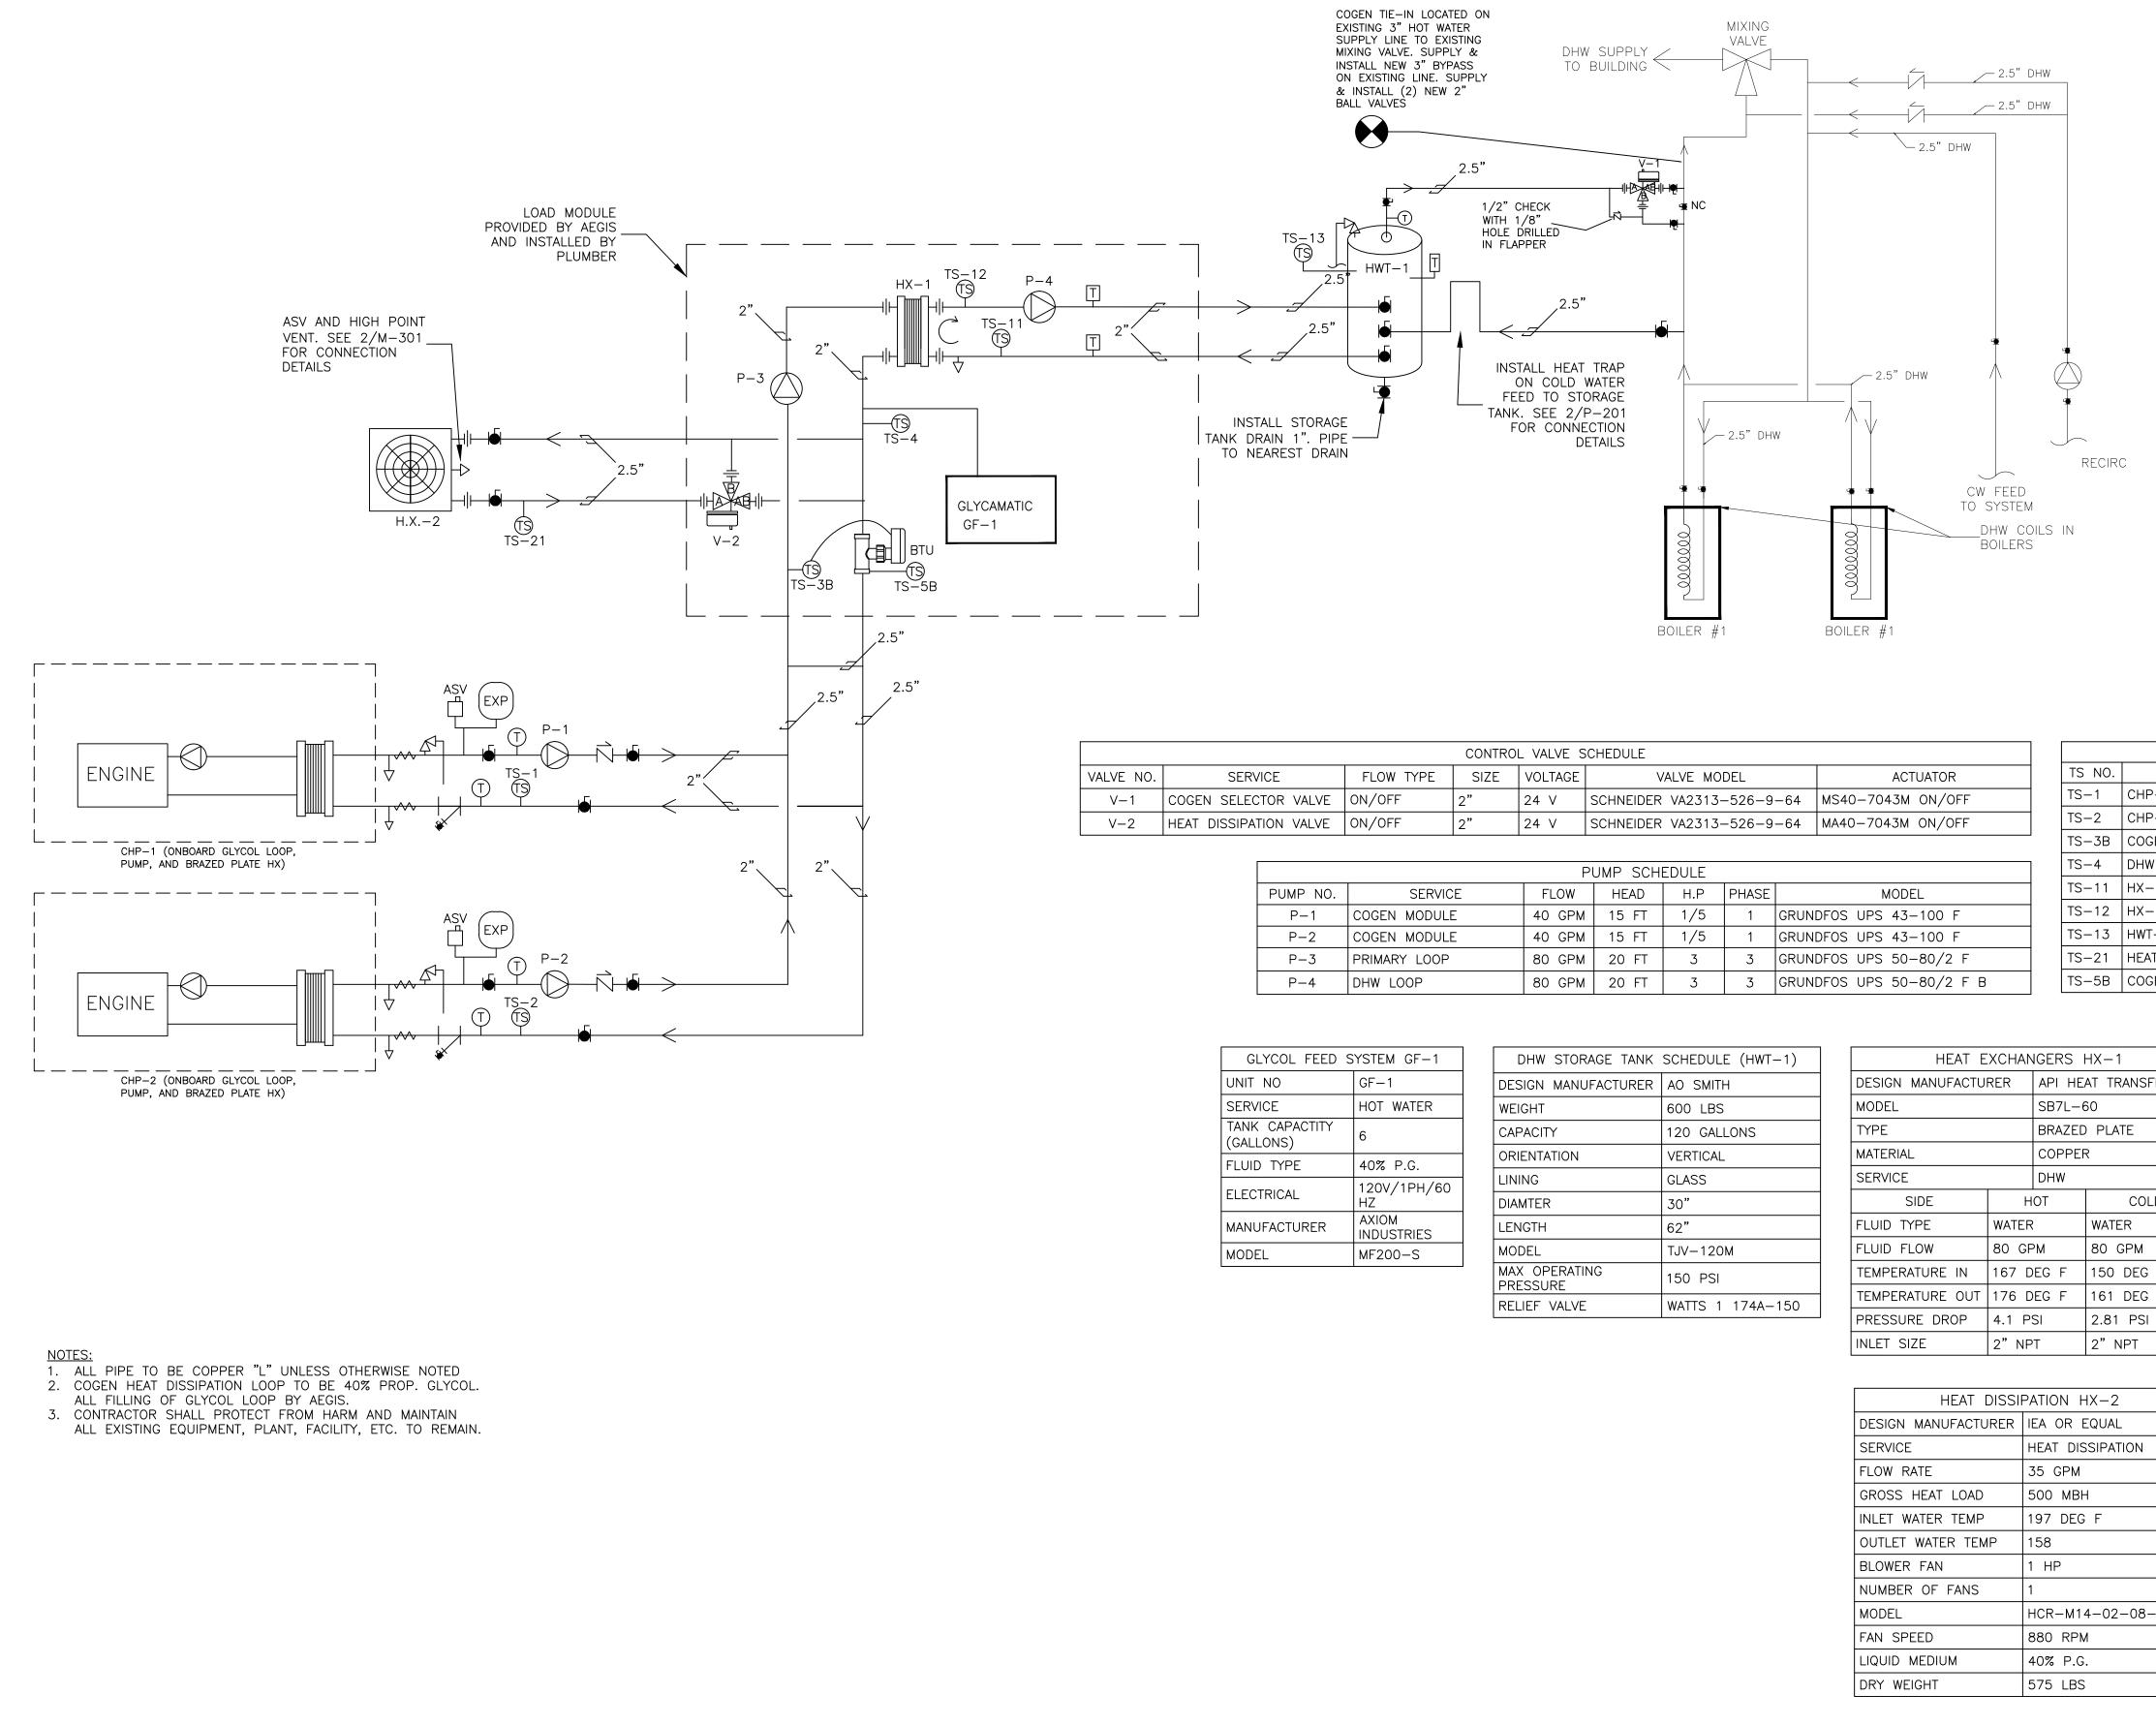

COGENERATION MECHANICAL FLOW DIAGRAM M-001

SCALE: NTS

		CONT	ROL VALVE S	SCHEDULE	TEMPERATURE SENSOR SCHEDULE						
VALVE NO.	LVE NO. SERVICE FLOW TYPE SIZE VOLTAGE VALVE MODEL					DDEL	ACTUATOR	TS NO.	SERVICE	MODEL	WELL TYPE
V-1	COGEN SELECTOR VALVE	ON/OFF 2"	24 V	SCHNEIDER			-64 MS40-7043M ON/OFF	TS-1	CHP-1 SUPPLY	PRTF-11-2-100-1/4-6-E-BX	AT-225
	HEAT DISSIPATION VALVE	ON/OFF 2"			· · · · · · · · · · · · · · · · · · ·	TS-2	CHP-2 SUPPLY	PRTF-11-2-100-1/4-6-E-BX	AT-225		
					TS-3B	COGEN SUPPLY	PRTF-11-2-100-1/4-6-E-BX	AT-225			
				PUMP SCH				TS-4	DHW-DUMP	PRTF-11-2-100-1/4-6-E-BX	AT-225
	PUMP NO.	SERVICE	FLOW	HEAD	H.P	PHASE	MODEL	TS-11	HX-1 RETURN	PRTF-11-2-100-1/4-6-E-BX	AT-225
	P-1 COGEN MODULE 40 GPM 15 FT 1/5 1 GRUNDFO P-2 COGEN MODULE 40 GPM 15 FT 1/5 1 GRUNDFO P-3 PRIMARY LOOP 80 GPM 20 FT 3 3 GRUNDFO				GRUNDFOS UPS 43-100 F	TS-12	HX-1 SUPPLY	PRTF-11-2-100-1/4-6-E-BX	AT-225		
					GRUNDFOS UPS 43-100 F	TS-13	HWT-1 TEMPERATURE	PRTF-11-2-100-1/4-6-E-BX	AT-225		
					GRUNDFOS UPS 50-80/2 F	TS-21	HEAT DISSIPATION	PRTF-11-2-100-1/4-6-E-BX	AT-225		
					GRUNDFOS UPS 50-80/2 F B	TS-5B	COGEN RETURN	BADGER 380	AT-225		


GLYCOL FEED S	SYSTEM GF-1
UNIT NO	GF-1
SERVICE	HOT WATER
TANK CAPACTITY (GALLONS)	6
FLUID TYPE	40% P.G.
ELECTRICAL	120V/1PH/60 HZ
MANUFACTURER	AXIOM INDUSTRIES
MODEL	MF200-S


DHW STORAGE TANK	SCHEDULE (HWT-1)
DESIGN MANUFACTURER	AO SMITH
WEIGHT	600 LBS
CAPACITY	120 GALLONS
ORIENTATION	VERTICAL
LINING	GLASS
DIAMTER	30"
LENGTH	62"
MODEL	TJV-120M
MAX OPERATING PRESSURE	150 PSI
RELIEF VALVE	WATTS 1 174A-150

HEAT EXCHANGERS HX-1							
DESIGN MANUFACTU	RER	API HE	AT TRANSFER				
MODEL		SB7L-6	50				
TYPE		BRAZED	PLATE				
MATERIAL		COPPER	२				
SERVICE		DHW					
SIDE	НОТ		COLD				
FLUID TYPE	WATER		WATER				
FLUID FLOW	80 GF	PM 80 GPM					
TEMPERATURE IN	167 D	EG F	150 DEG F				
TEMPERATURE OUT	176 D	EG F	161 DEG F				
PRESSURE DROP	4.1 P	SI 2.81 PSI					
INLET SIZE	2" NP	'T	2" NPT				


HEAT DISSIPATION HX-2						
DESIGN MANUFACTURER	IEA OR EQUAL					
SERVICE	HEAT DISSIPATION					
FLOW RATE	35 GPM					
GROSS HEAT LOAD	500 MBH					
INLET WATER TEMP	197 DEG F					
OUTLET WATER TEMP	158					
BLOWER FAN	1 HP					
NUMBER OF FANS	1					
MODEL	HCR-M14-02-08-S01					
FAN SPEED	880 RPM					
LIQUID MEDIUM	40% P.G.					
DRY WEIGHT	575 LBS					


COGENERATIO	N SCHEDULE
DESIGN MANUFACTURER	YANMAR
FUEL	NATURAL GAS
FUEL INPUT	410 CFH
THERMAL OUTPUT	202,000 BTU/HR
ELECTRICAL OUTPUT	35 KW, 208V
GENERATION TYPE	DG GENERATOR – INVERTER
ACOUSTIC LEVEL	64 dB (A)
VIBRATION ISOLATION	YES
CONTROLS	MICROPROCESSOR BASED
UNIT WEIGHT	3,374
MODEL	CP35D1
NOMINAL INLET TEMP	167 DEG F
NOMINAL OUTLET TEMP	176 DEG F
NOMINAL WATER FLOW RATE	39.6 GPM
DIMENSIONS	32"W X "79 X 79"H

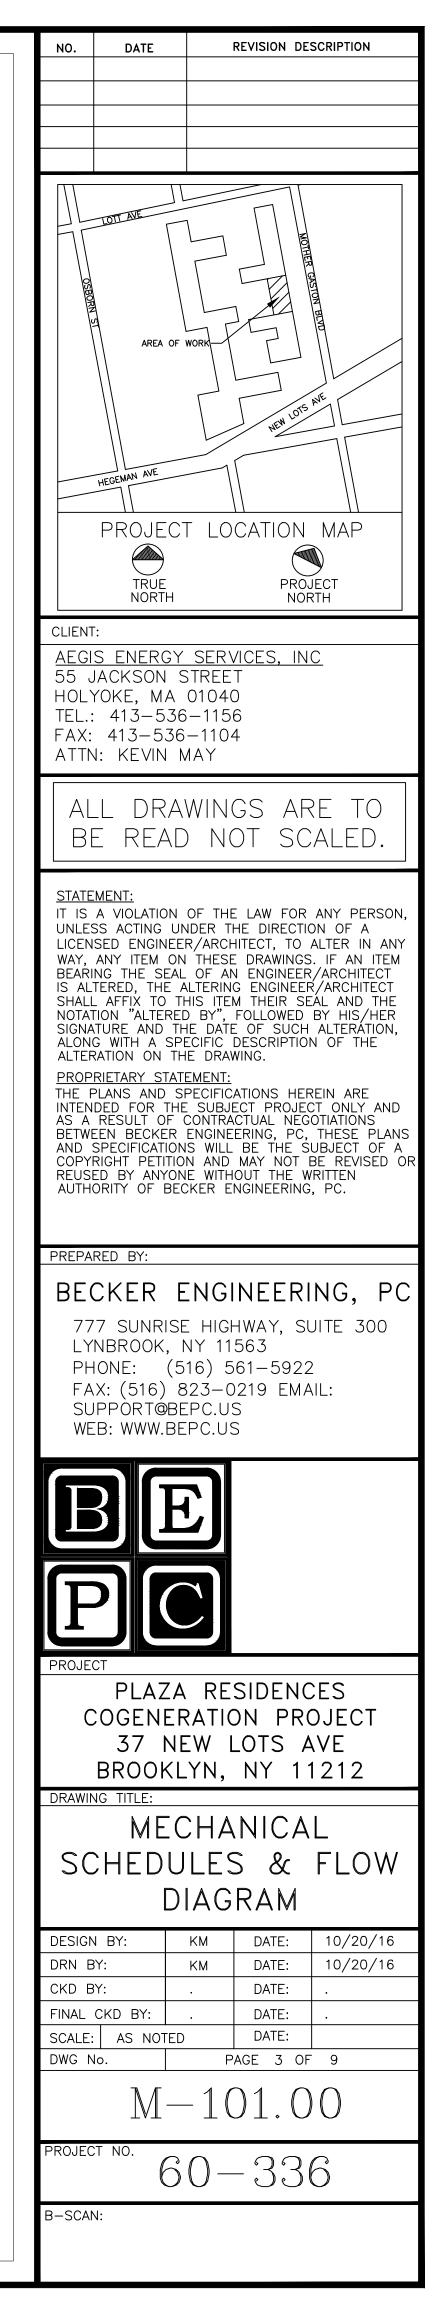


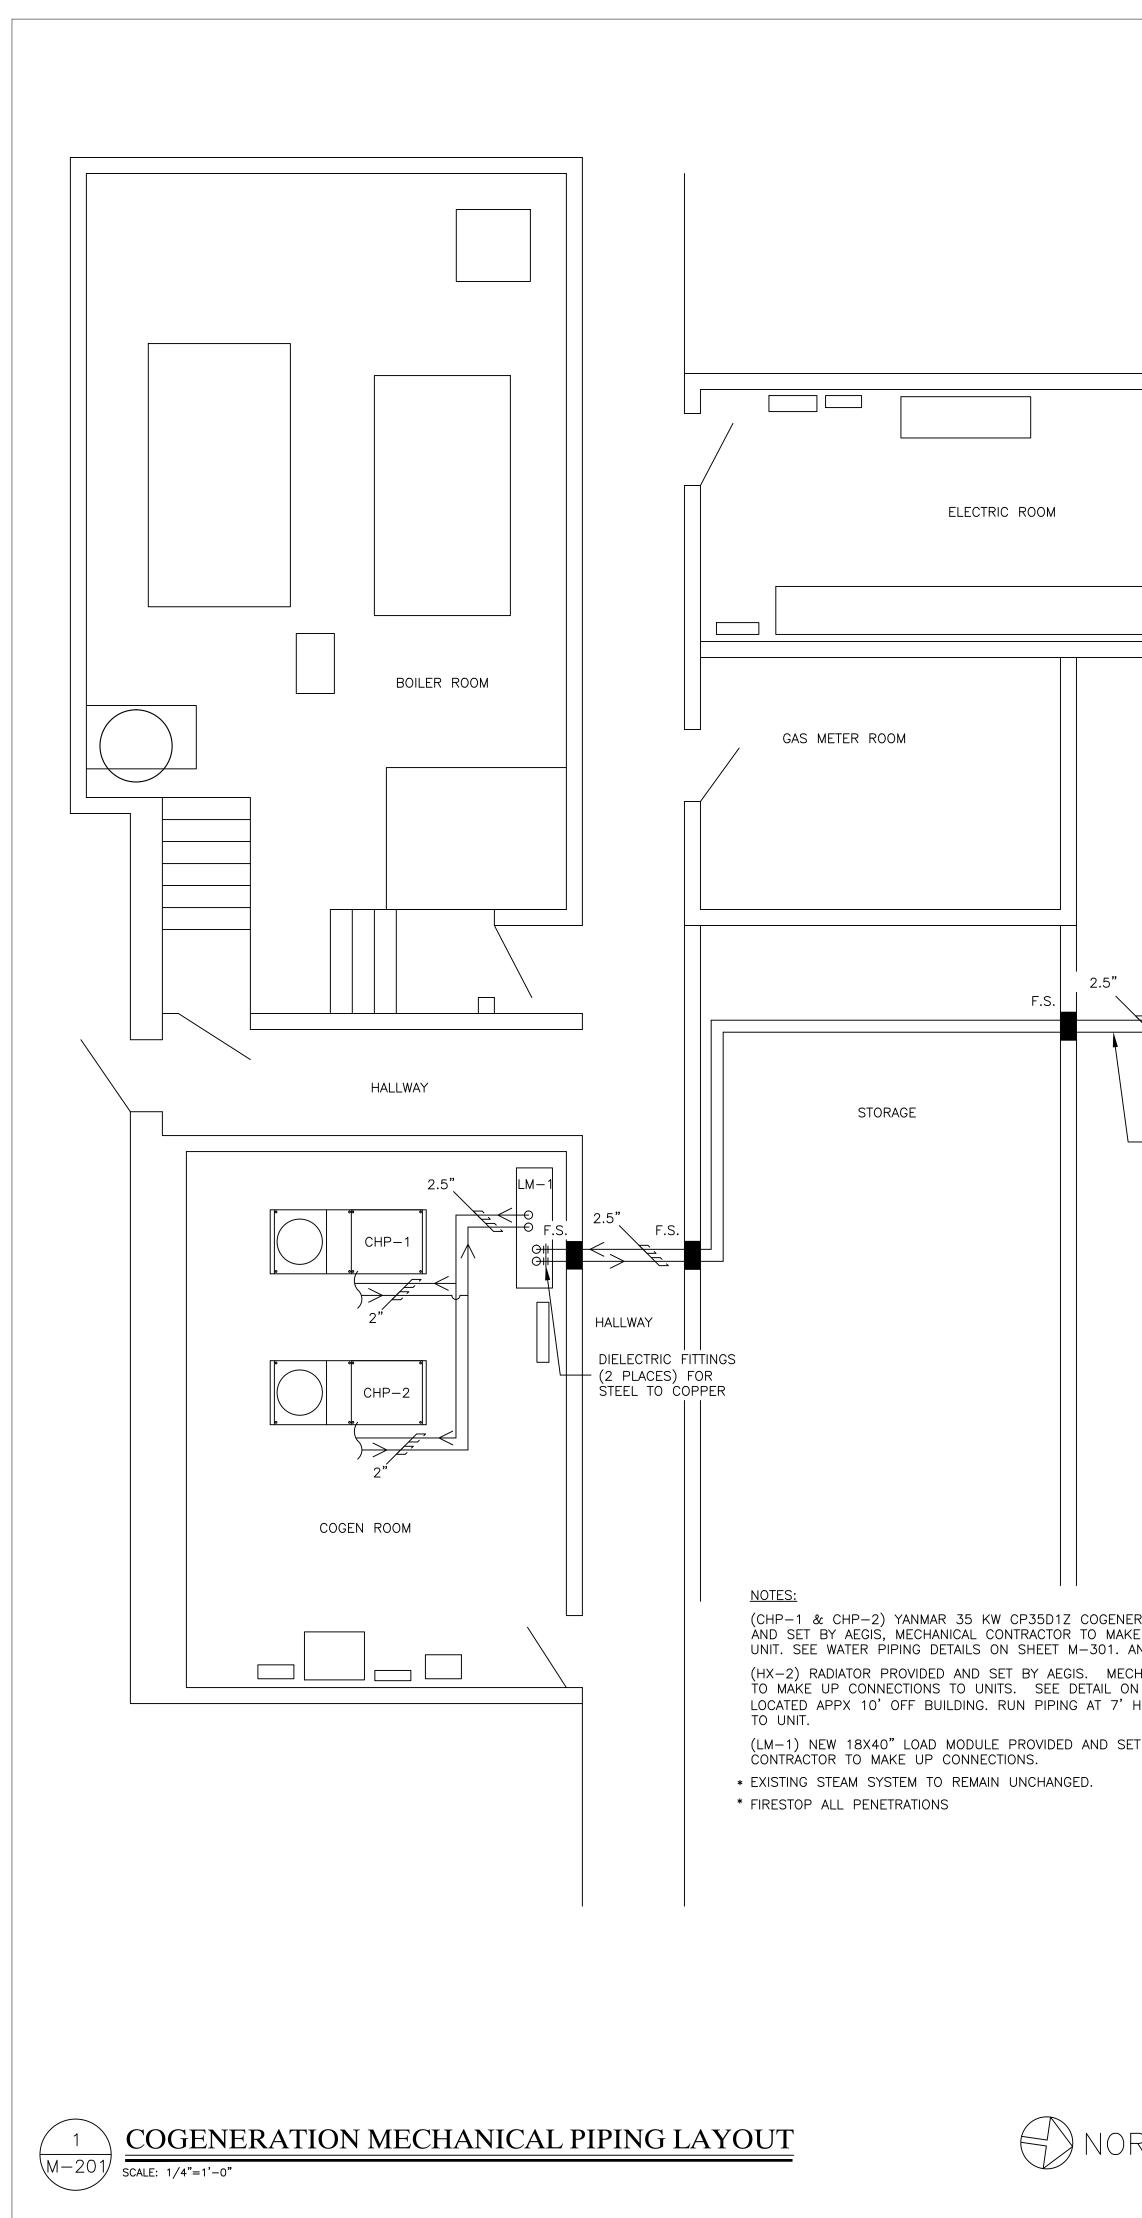

KEEP PIPES ~7"HIGH OFF THE GROUND	NOTES: (CHP-1 & CHP-2) YANMAR 35 KW CP35D1Z COGENERATION UNIT, PROVIDED AND SET BY AEGIS, MECHANICAL CONTRACTOR TO MAKE CONNECTIONS UP TO AND SET BY AEGIS, MECHANICAL CONTRACTOR TO MAKE CONNECTIONS UP TO
	 UNIT. SEE COMBUSTION EXHAUST, DUCT, AND RADIATOR PIPING DETAILS ON SHEET M-003. (F-1 & F-2) FANTECH FKD-16XL OR SIMILAR, PROVIDED BY AEGIS, MECHANICAL CONTRACTOR TO INSTALL. INSTALL WITH VIBRATION ISOLATORS FROM CEILING AND USE FLEXIBLE CONNECTORS ON INLET AND OUTLET. (MD-1) NEW 24X36" MOTORIZED DAMPER PROVIDED BY AEGIS AND INSTALLED BY MECHANICAL CONTRACTOR ON EXISTING LOUVER PLENUM, FOR INTAKE AIR. SHIFT EXISTING INLET FAN AND MODIFY PLENUM TO ACCOMODATE. SEE M-301 FOR DETAILS. (CC-1 & CC-2) INSTALL NEW CONDENSATE CONDITIONER AXIOM MODEL NC-1. MOUNT ON GROUND, CONNECT FLEX HOSE FROM UNIT DIRECTLY TO INLET. RUN COPPER 3/4" PIPING TO NEAREST FLOOR DRAIN. (1) (2 PLACES) TIE COGEN COMBUSTION EXHAUST INTO EXISTING CHIMNEY. PENETRATE THROUGH CHIMNEY AND SEAL WITH HIGH TEMP RTV. SEE M-301 FOR DETAILS. (2) (2 PLACES) CORE DRILL 16" THROUGH WALL AND FOR COGEN MECHANICAL EXHAUST. TERMINATE WITH TURNDOWN AND BIRD SCREEN (3) (2 PLACES) INSTALL 16" DIA RETURN GRILLE IN END OF TEE. SEE M-301 FOR DETAILS. * EXISTING STEAM SYSTEM TO REMAIN UNCHANGED. * FIRESTOP ALL PENETRATIONS
ERATION UNIT, PROVIDED XE CONNECTIONS UP TO AND OUTLET. CHANICAL CONTRACTOR N SHEET M-301. HEIGHT ACROSS GRASS ET BY AEGIS.	
RTH	2 M-201 COGENERATION HOT AIR EXHAUST & FLUE LAYOU

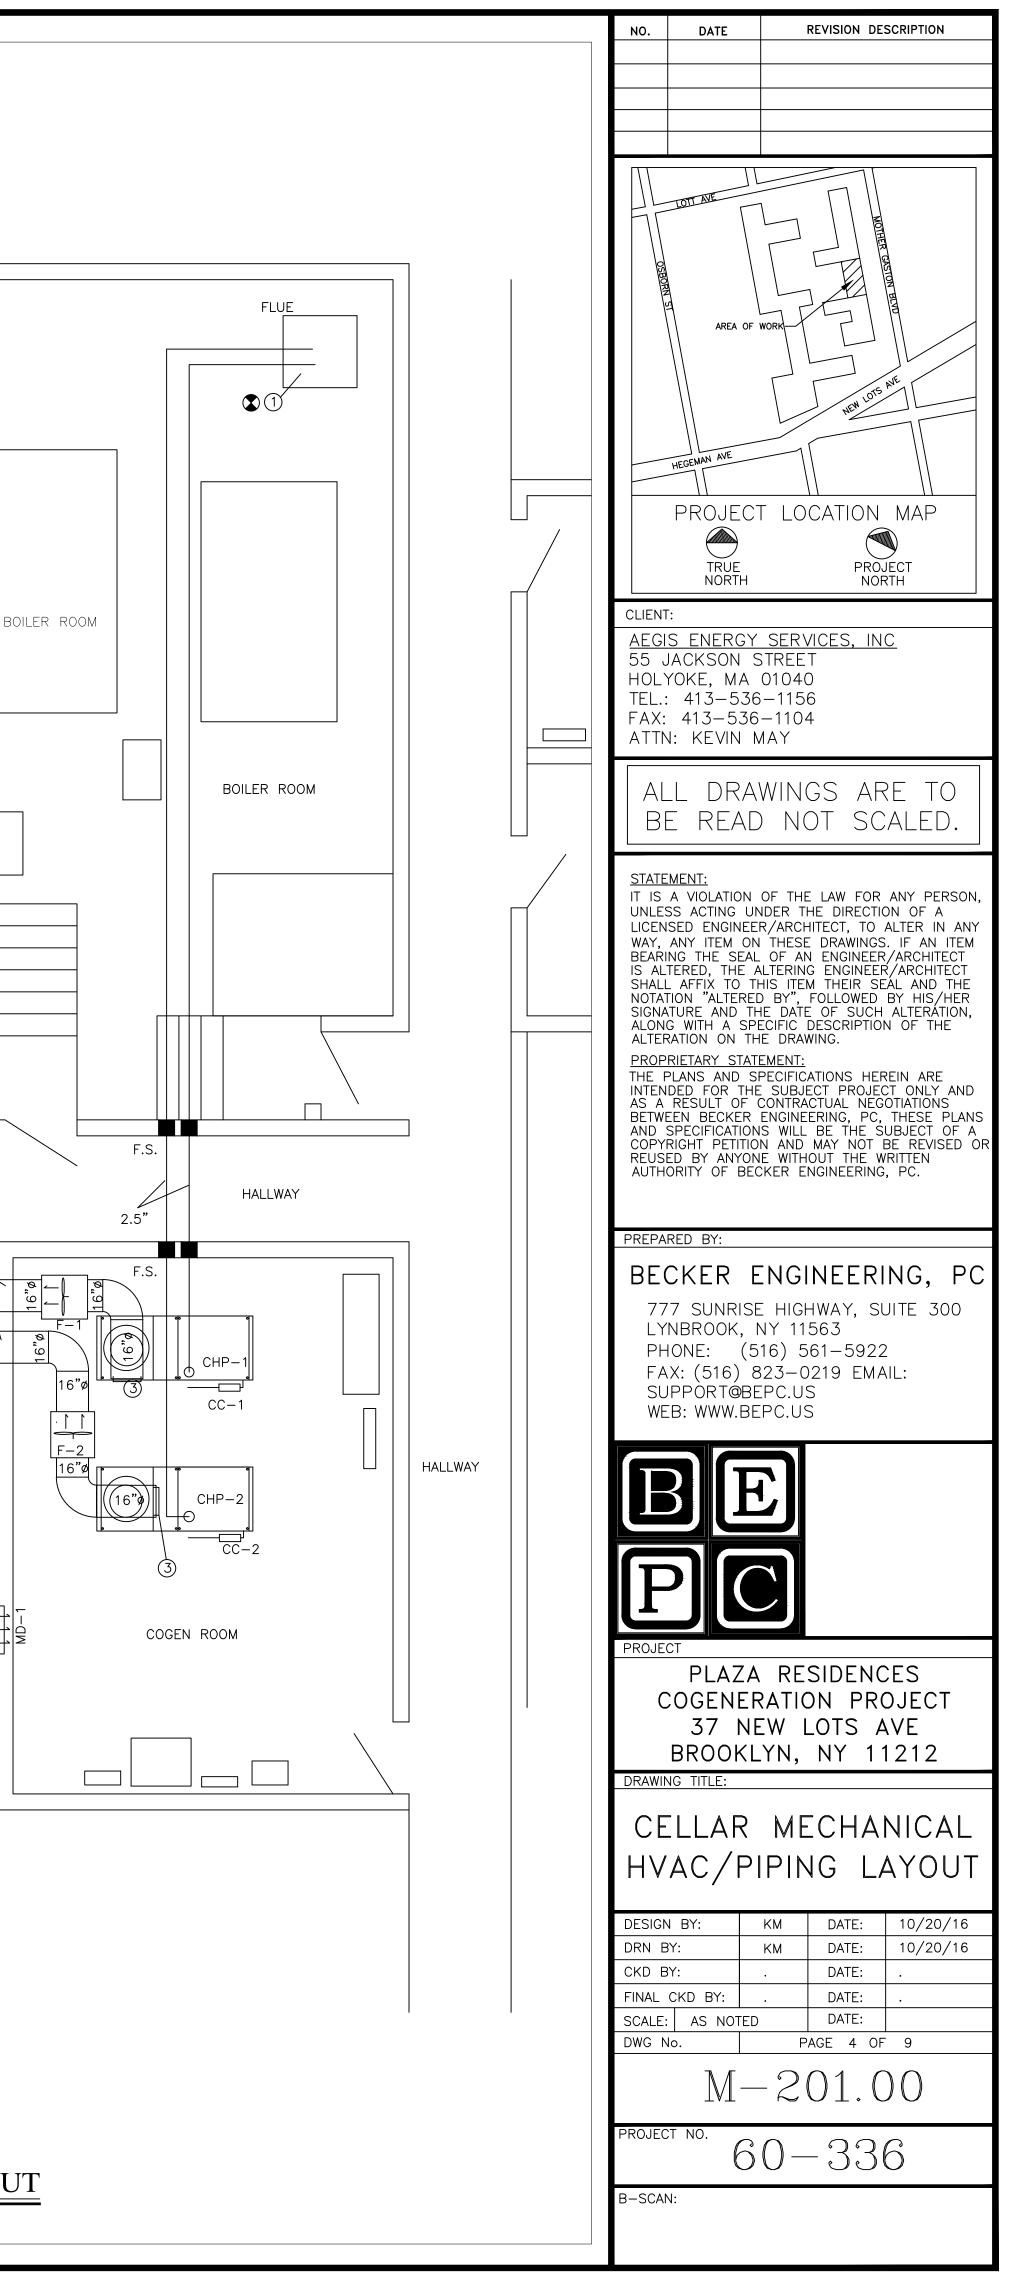


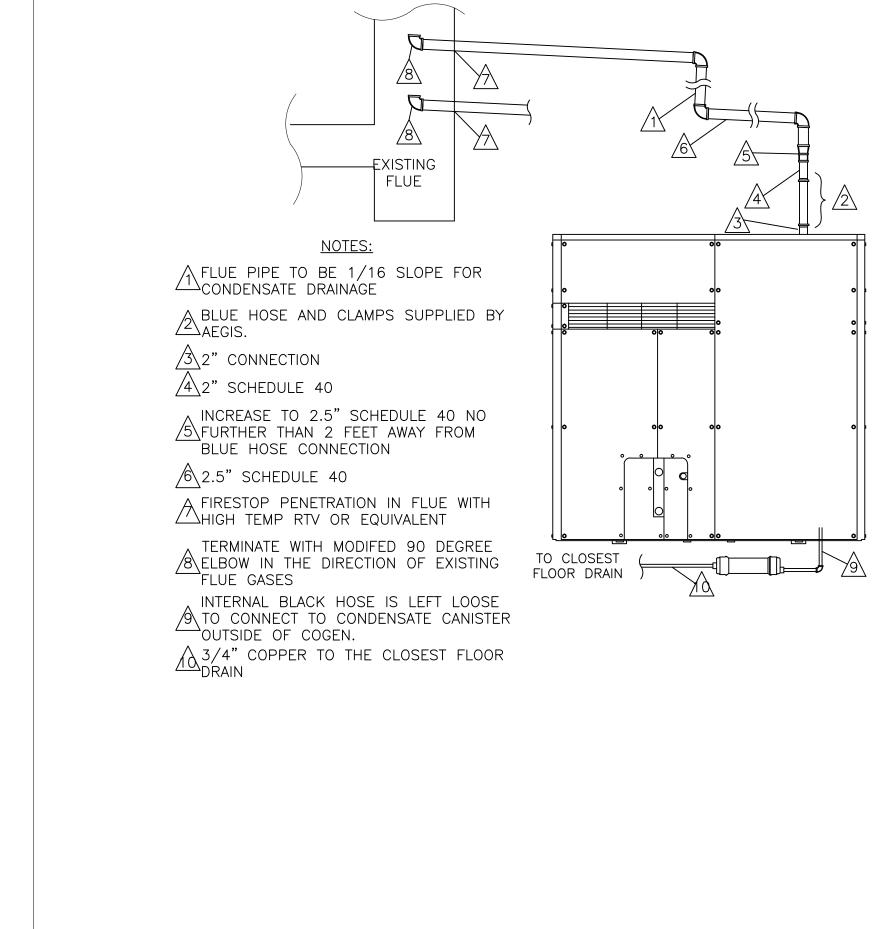


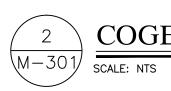

COGENERATION FLUE DETAIL



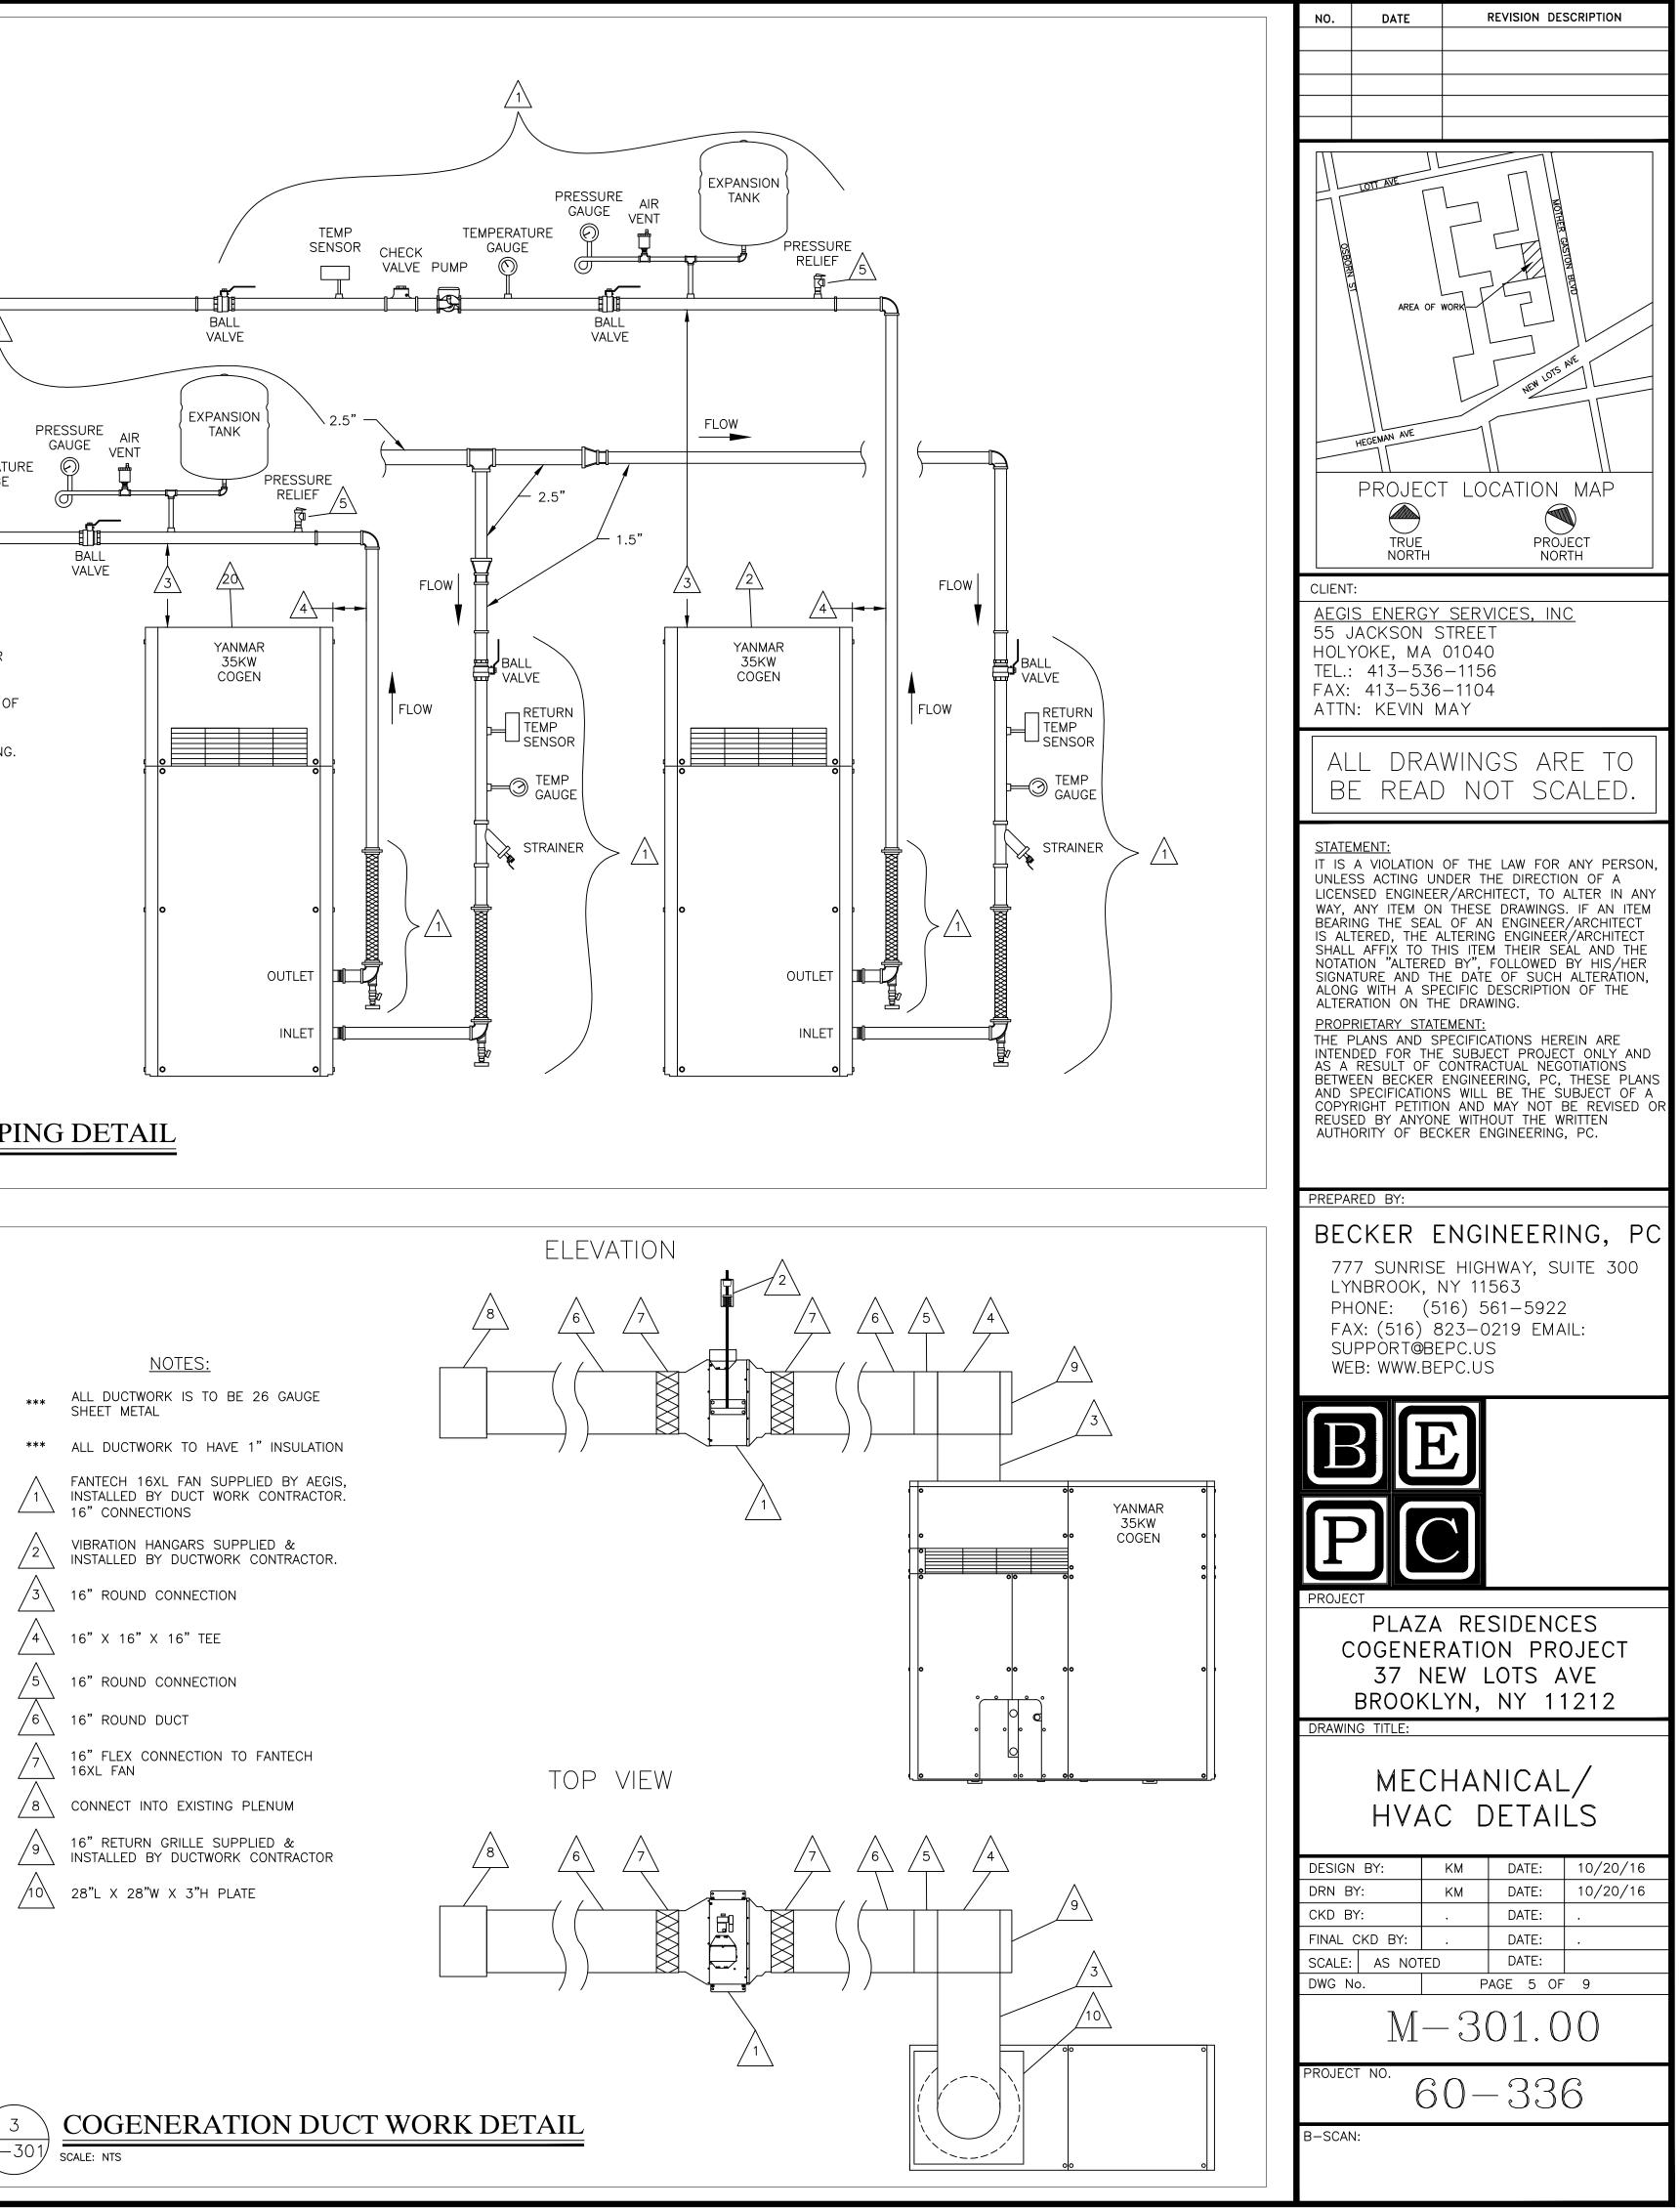

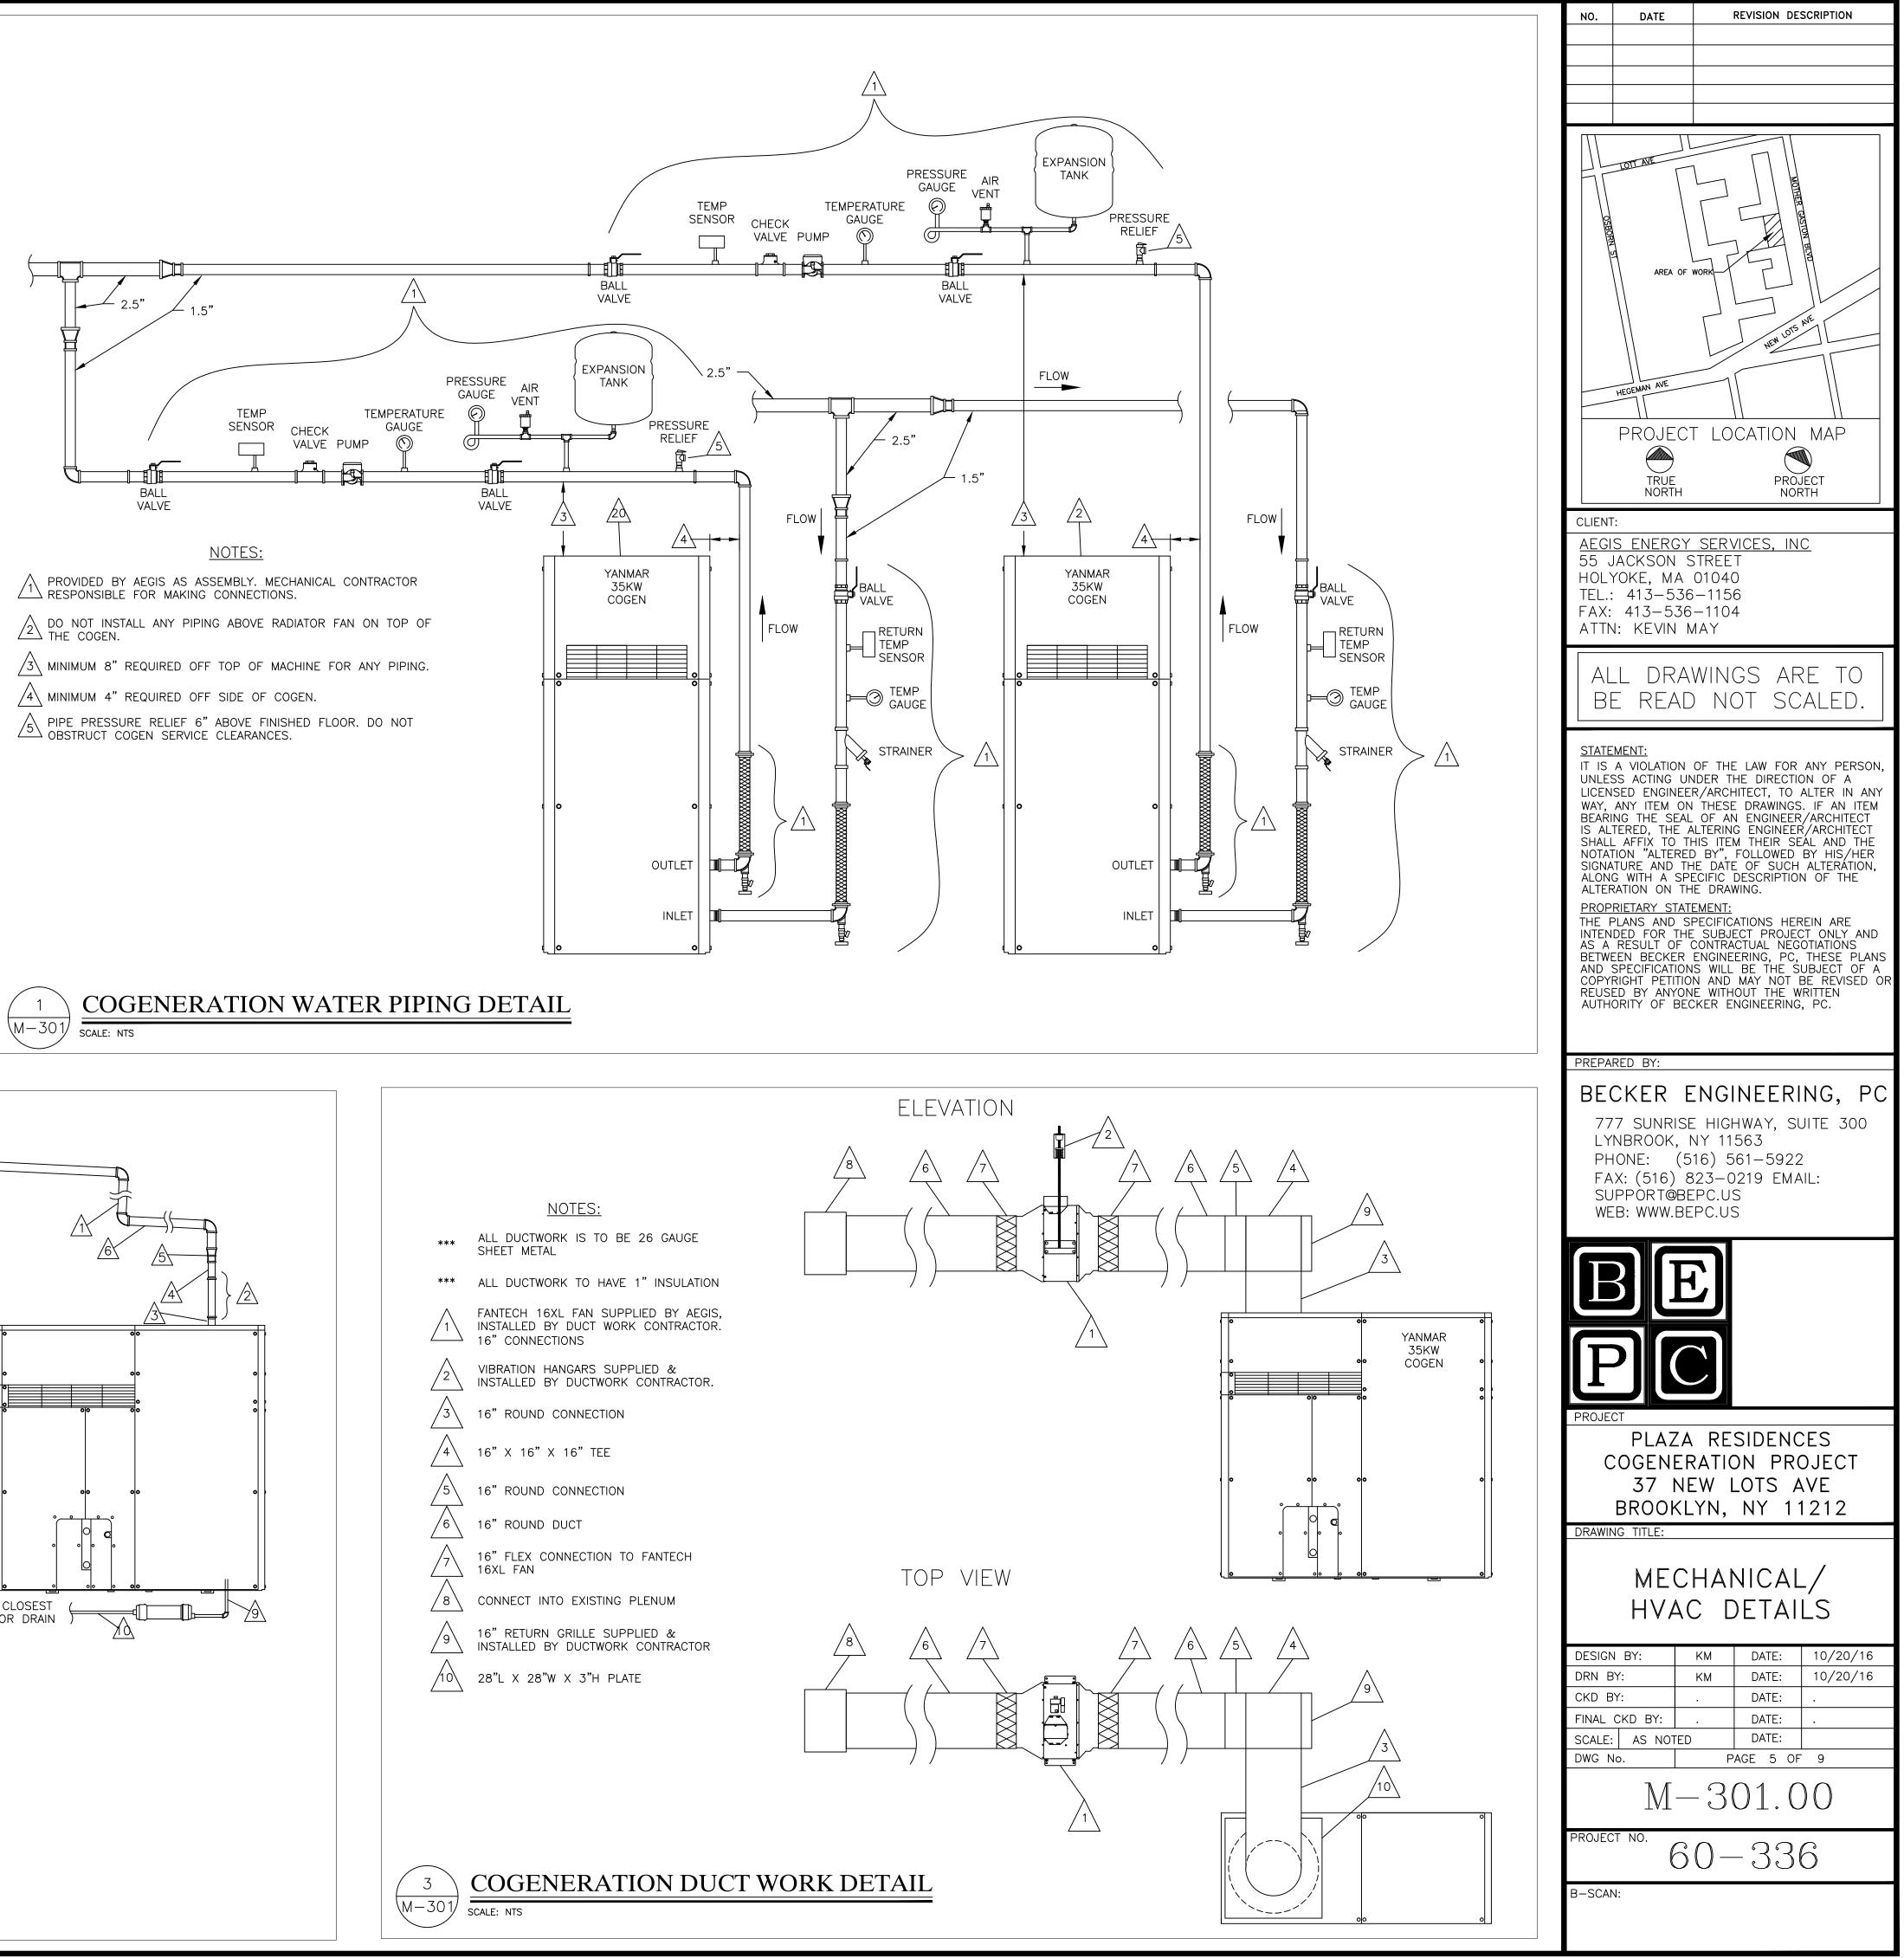

SEE 2/P-201 FOR CONNECTION DETAILS. INSTALL HEAT TRAP ON COLD WATER FROM BUILDING LINE

NOTES:

(CHP-1 & CHP-2) PROVIDED AND SET BY AEGIS, PLUMBER TO MAKE CONNECTIONS UP TO UNIT. INSTALL FLEX CONNECTORS SUPPLIED BY AEGIS AT UNIT. INSTALL GAS UNION AND SHUTOFF VALVE ON UNIT.

(LM-1) PROVIDED AND SET BY AEGIS, PLUBBER TO MAKE UP ALL CONNECTIONS TO UNIT. SEE DETAILS ON M-101

(HWT-1) PROVIDED AND SET BY AEGIS, PLUMBER TO MAKE CONNECTIONS UP TO TANKS. INSTALL VALVES AT TANK ON ALL LINES, INSTALL AEGIS SUPPLIED PRV TO TANK AND PIPE TO FLOOR. INSTALL SENSOR, GAGE & RELIEF PROVIDED BY AEGIS ONTO TANK. INSTALL 1" DRAIN ON TANK. SEE M-101 & P-201 FOR DETAILS.

(V-1) VALVE AND UNIONS PROVIDED BY AEGIS, ALL OTHER COMPONENTS PROVIDED BY PLUMBER. TIE INTO EXISTING LINES AS SHOWN. INCREASE PIPING SIZE TO 2.5" AFTER 3-WAY VALVE

(GM-CG) NEW RM-2000 GAS METER PROVIDED BY AEGIS, INSTALLED BY PLUMBER. PLUMBER TO PROVIDE MATCHING FLANGES AND GASKETS.


(GM-UTIL) PLUMBER TO INSTALL NEW UTILITY GAS METER, REGULATOR, (1) EXTERIOR VENTING, AND ALL REQUIRED ACCESSORIES PER NGRID SPECS. 820CFH, 14" WC.


- TIE INTO EXISTING 3" HOT LINE OF DHW SYSTEM, 2 PLACES. USE 2" PIPING (2) FOR TAPS AND INTO 3-WAY VALVE, BUT LIMIT TOTAL FOOTAGE OF 2" PIPING TO 6' AND USE NO MORE THAN 1 ELBOWS. SEE 1/M-101 FOR DETAILS.
- TIE INTO EXISTING 3" COLD LINE OF DHW SYSTEM. 2.5" LINE WITH VALVE. (3) SEE 1/M-101 FOR DETAILS




COGENERATION CELLAR PLUMBING LAYOUT



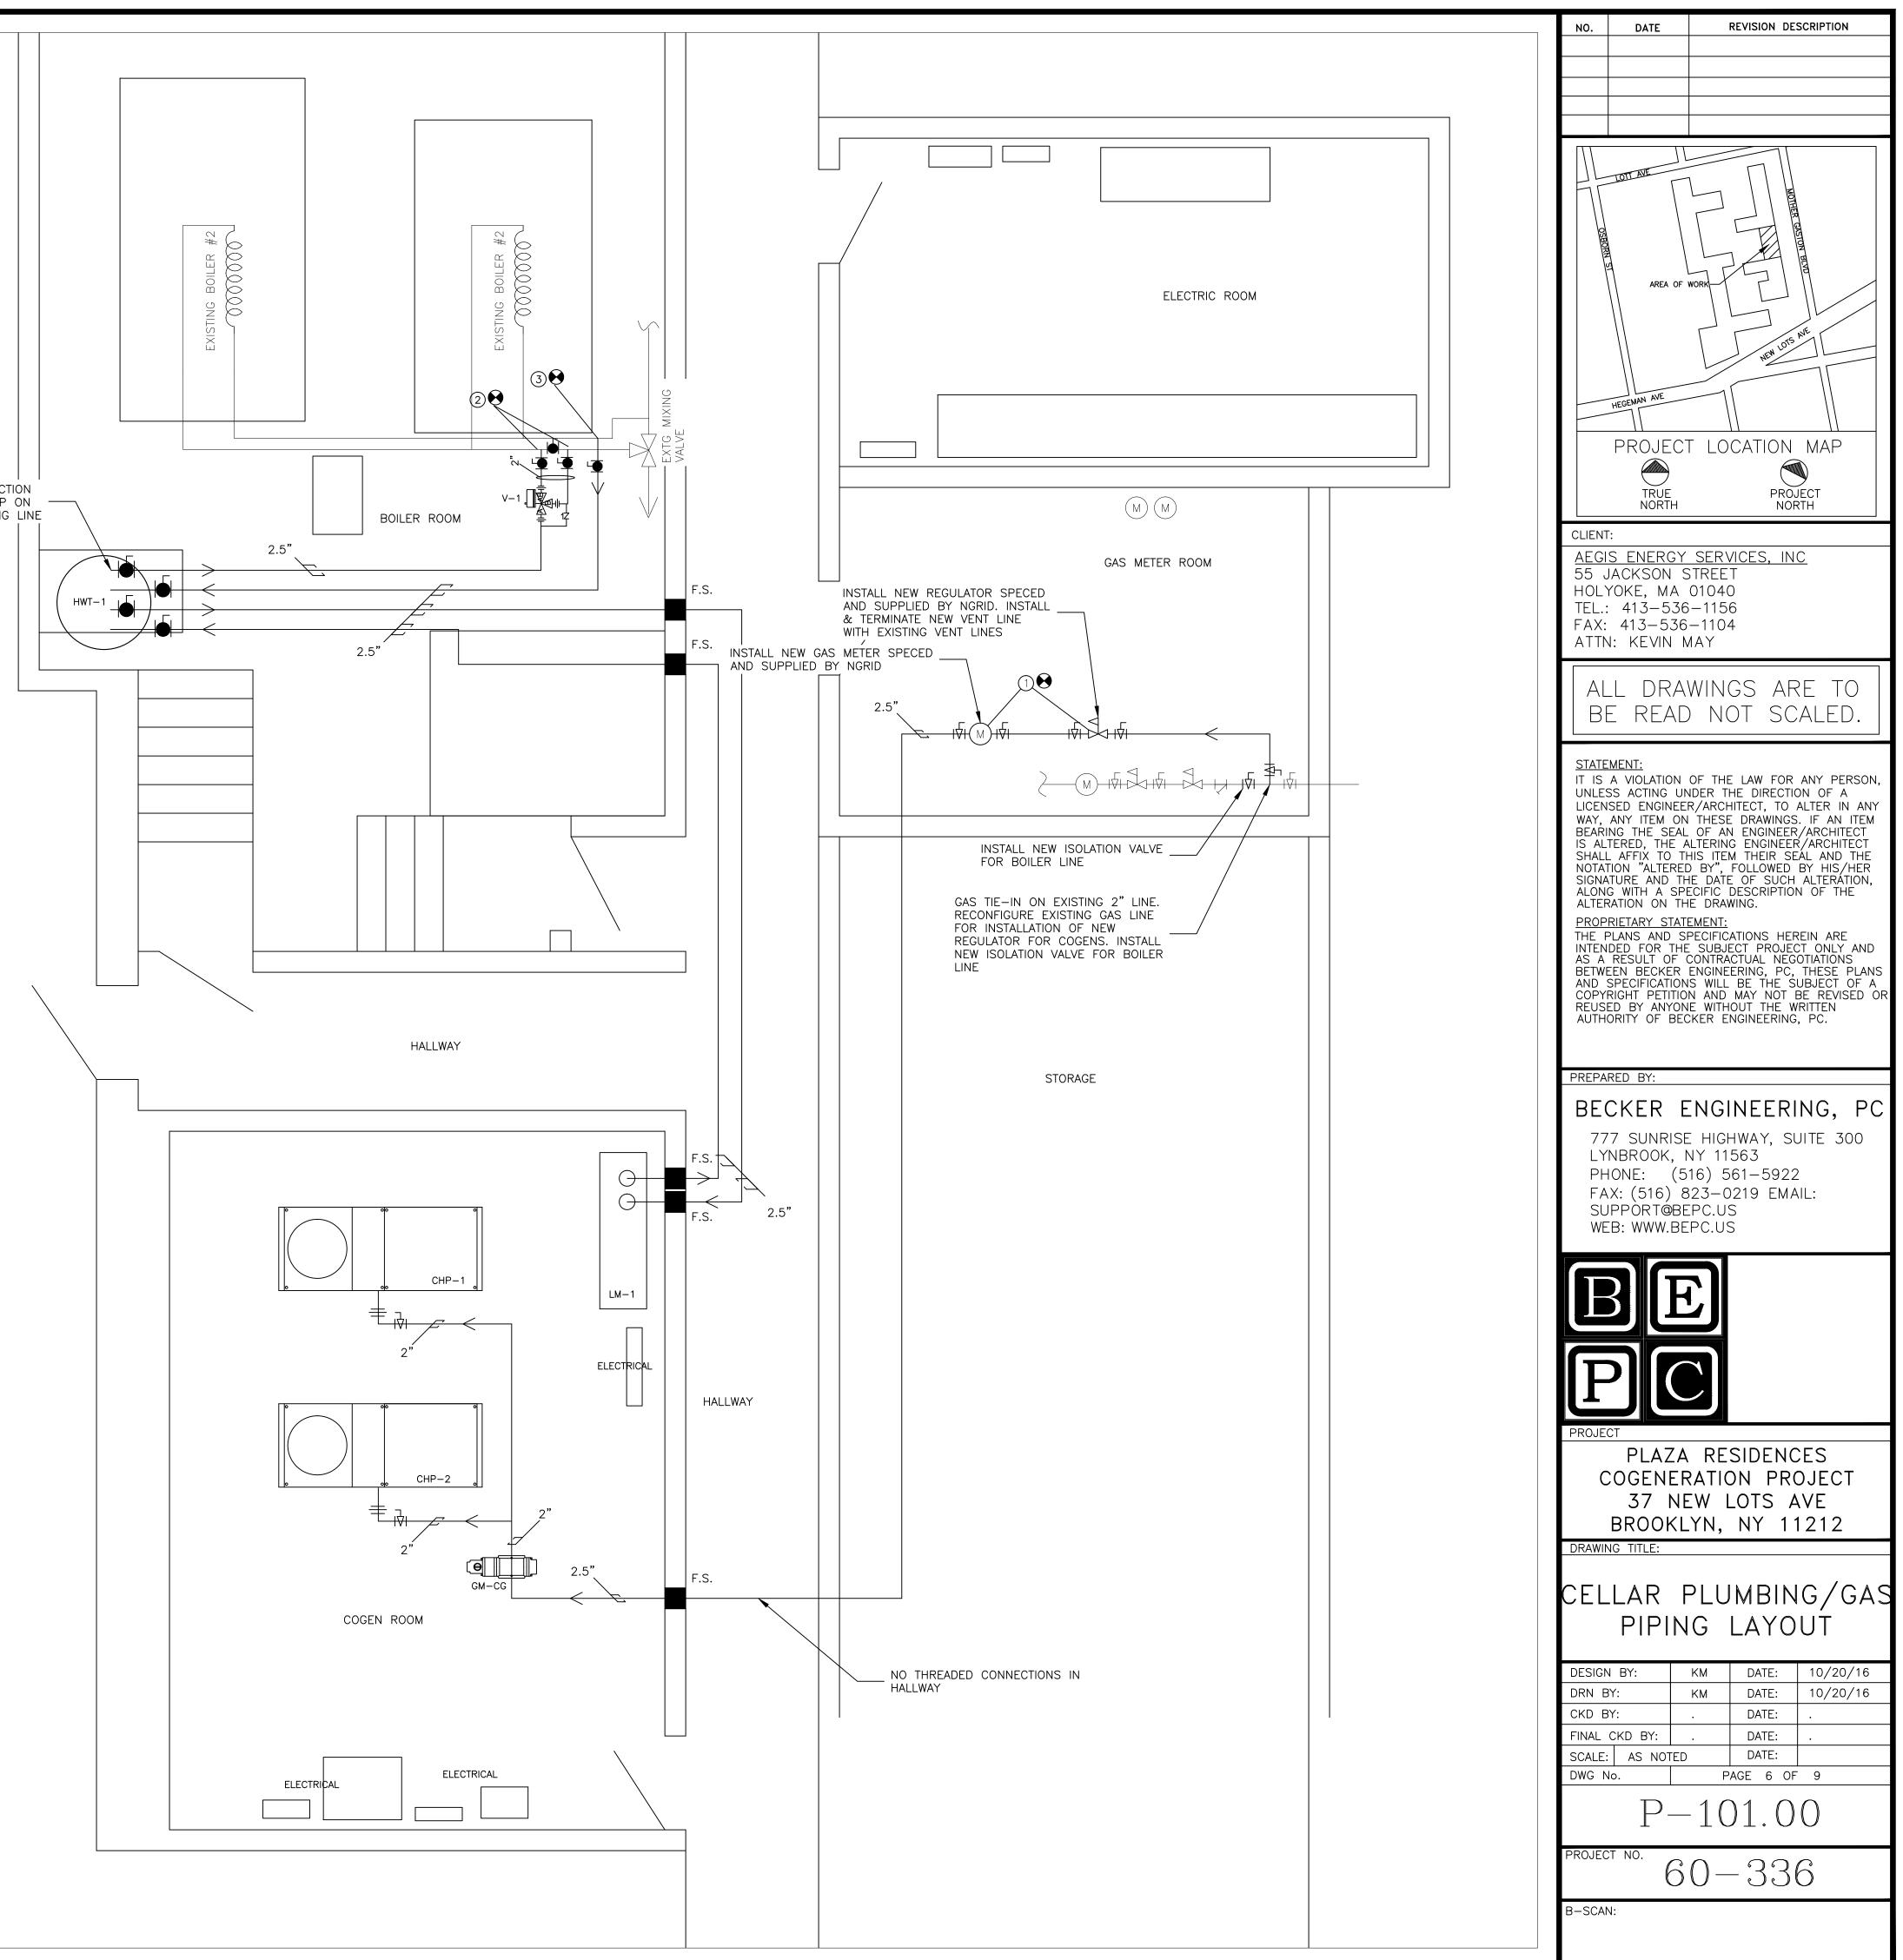

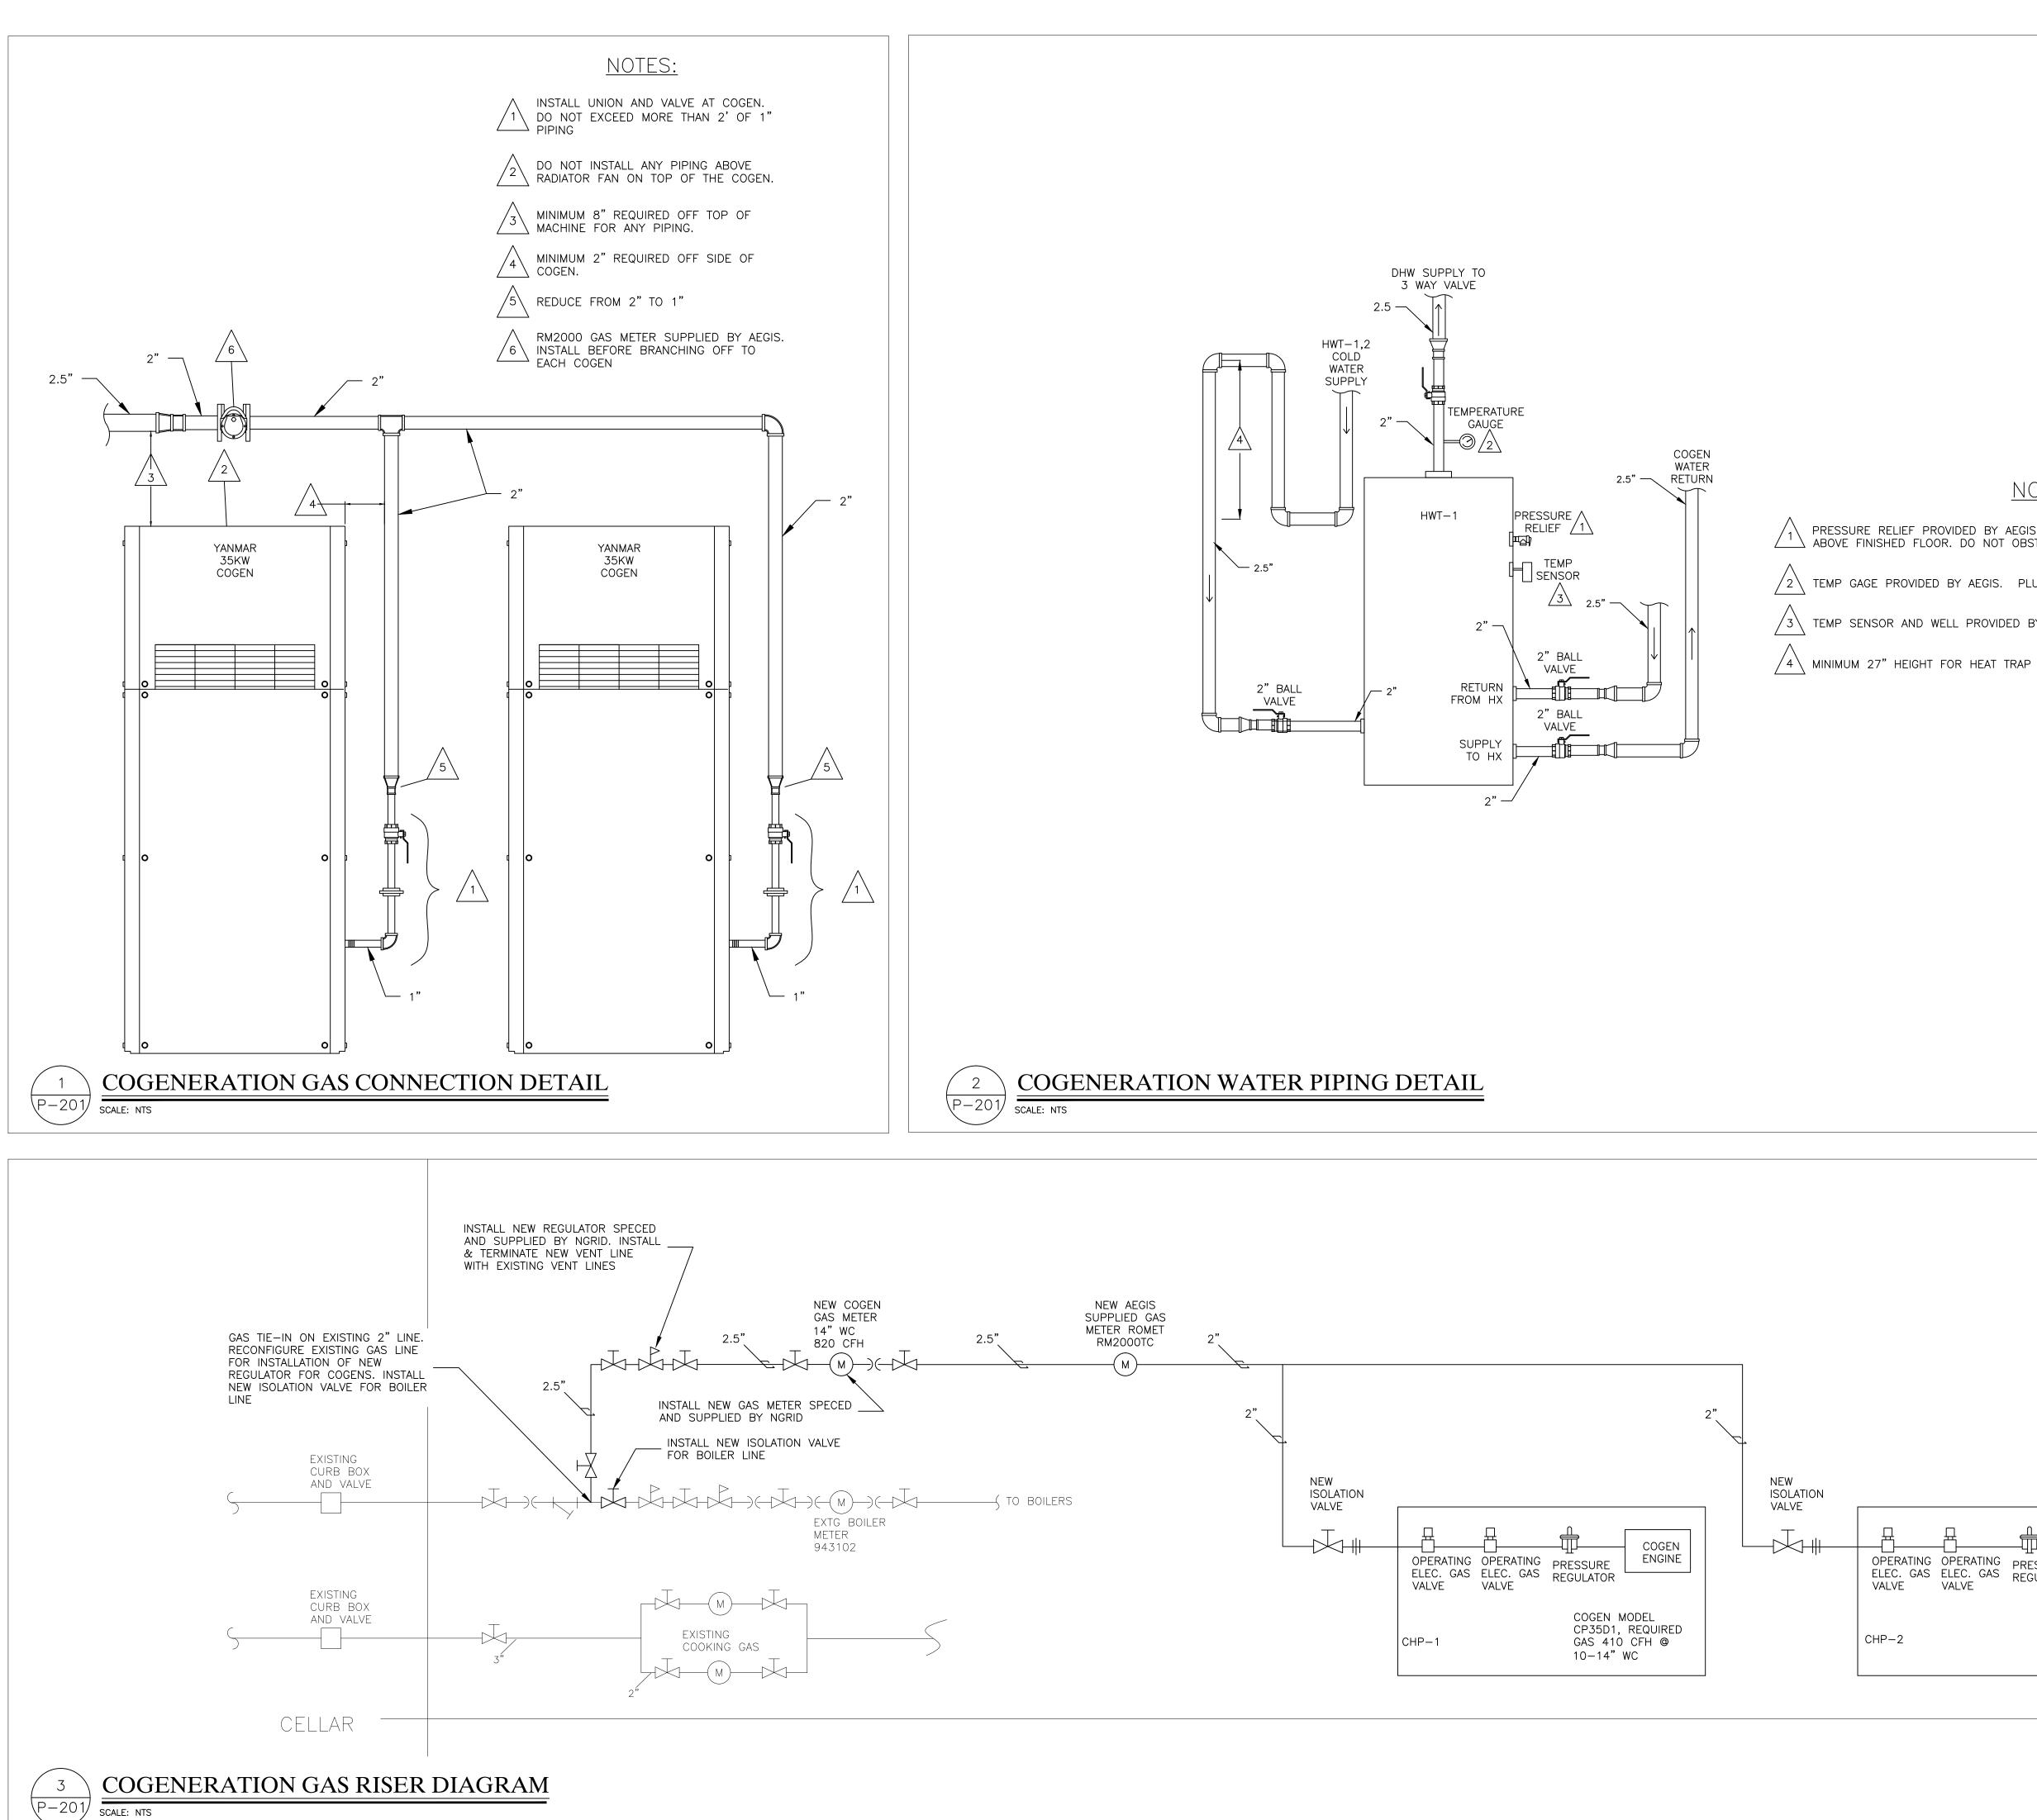

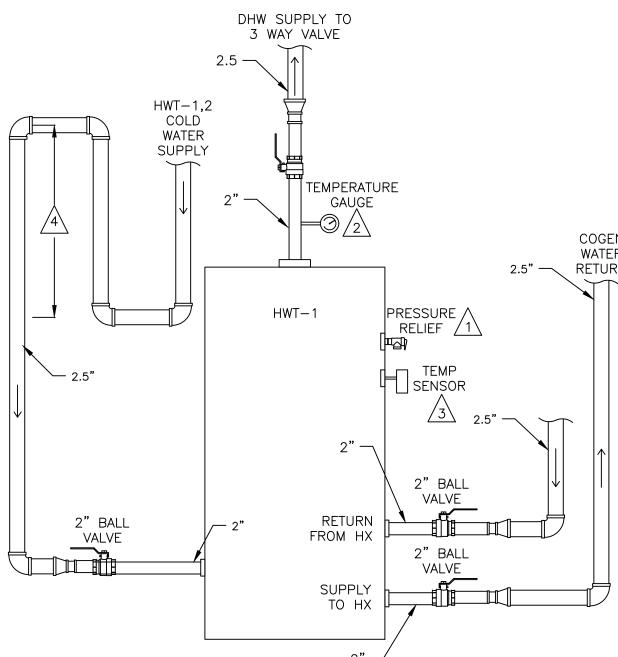





<u>NOTES:</u>

PRESSURE RELIEF PROVIDED BY AEGIS. PLUMBER TO INSTALL AND PIPE TO 6" ABOVE FINISHED FLOOR. DO NOT OBSTRUCT TANK CONNECTIONS

/2 TEMP GAGE PROVIDED BY AEGIS. PLUMBER TO INSTALL.

/3 TEMP SENSOR AND WELL PROVIDED BY AEGIS. PLUMBER TO INSTALL WELL IN TANK.

G OPERATING S ELEC. GAS VALVE	PRESSURE REGULATOR	COGEN ENGINE
	CP35 GAS	N MODEL D1, REQUIRED 410 CFH @ 4" WC

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IT IS A VIOLATION OF THE LAW FOR ANY PERSON, UNLESS ACTING UNDER THE DIRECTION OF A LICENSED ENGINEER/ARCHITECT, TO ALTER IN ANY WAY, ANY ITEM ON THESE DRAWINGS. IF AN ITEM BEARING THE SEAL OF AN ENGINEER/ARCHITECT IS ALTERED, THE ALTERING ENGINEER/ARCHITECT IS ALTERED, THE ALTERING ENGINEER/ARCHITECT IS ALTERED BY", FOLLOWED BY HIS/HER NOTATION "ALTERED BY", FOLLOWED BY HIS/HER NOTATION ON THE DATE OF SUCH ALTERATION, ALONG WITH A SPECIFIC DESCRIPTION OF THE ALTERATION ON THE DATE OF SUCH ALTERATION, ALONG WITH A SPECIFIC DESCRIPTION OF THE ALTERATION ON THE DRAWING. PROPRIETARY STATEMENT: THE PLANS AND SPECIFICATIONS HEREIN ARE INTENDED FOR THE SUBJECT PROJECT ONLY AND AS A RESULT OF CONTRACTUAL NECOTINATIONS BETWEEN BECKER ENGINEERING, PC, THESE PLANS AND SPECIFICATIONS WILL BE THE SUBJECT OF A COPYRIGHT PETITION AND MAY NOT BE REVISED OF REUSED BY ANYONE WITHOUT THE WRITTEN AUTHORITY OF BECKER ENGINEERING, PC. PREPARED BY: BECKER ENGINEERING, PC, SUITE 300 LYNBROOK, NY 11563 PHONE: (516) 561–5922 FAX: (516) 823–0219 EMAIL: SUPPORTOBEPC.US WEB: WWW.BEPC.US WEB: WWW.BEPC.US WEB: WWW.BEPC.US WEB: WWW.BEPC.US WEB: WWW.BEPC.US WEB: WWW.BEPC.US DESIGN BY: KM DATE: 10/20/16 CAS RISER DIAGRAM & PLUMBING DETAILS DESIGN BY: KM DATE: 10/20/16 CRD BY: N DATE: . FINAL CKD BY: . DATE: . SCALE: AS NOTED DATE: . DEGALE: AS NOTED DATE: . PC-201.000 PROJECT NO. BC0-336			
BECKER ENGINEERING, PC 777 SUNRISE HIGHWAY, SUITE 300 LYNBROOK, NY 11563 PHONE: (516) 561–5922 FAX: (516) 823–0219 EMAIL: SUPPORT@BEPC.US WEB: WWW.BEPC.US WEB: WWW.BEPC.US PROJECT PLAZA RESIDENCES COGENERATION PROJECT 37 NEW LOTS AVE BROOKLYN, NY 11212 DRAWING TITLE: GAS RISER DIAGRAM & PLUMBING DETAILS DESIGN BY: KM DATE: 10/20/16 DRN BY: KM DATE: 10/20/16 CKD BY: . DATE: . FINAL CKD BY: . DATE: . PC-201.00	IT IS UNLES LICEN WAY, BEARI IS AL SHALI NOTA SIGNA ALON ALON THE F INTEN AS A BETWI AND COPY REUS	A VIOLATION SS ACTING UN SED ENGINEE ANY ITEM ON NG THE SEAL TERED, THE A AFFIX TO TH TION "ALTEREN TURE AND TH ATION ON TH RIETARY STAT PLANS AND S DED FOR THE RESULT OF T EN BECKER SPECIFICATION RIGHT PETITIO ED BY ANYON	NDER THE DIRECTION OF A R/ARCHITECT, TO ALTER IN ANY N THESE DRAWINGS. IF AN ITEM OF AN ENGINEER/ARCHITECT ALTERING ENGINEER/ARCHITECT 'HIS ITEM THEIR SEAL AND THE D BY", FOLLOWED BY HIS/HER HE DATE OF SUCH ALTERATION, 'ECIFIC DESCRIPTION OF THE HE DRAWING. <u>'EMENT:</u> SPECIFICATIONS HEREIN ARE E SUBJECT PROJECT ONLY AND CONTRACTUAL NEGOTIATIONS ENGINEERING, PC, THESE PLANS NS WILL BE THE SUBJECT OF A ON AND MAY NOT BE REVISED OF NE WITHOUT THE WRITTEN
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	FEEDER SCHEDULE 1-3										
KEY	DESCRIPTION	VOLTAGE	AMPS	# SETS	CONDUCTOR SIZE	NEUTRAL SIZE	GROUND SIZE	EMT SIZE			
1	COGEN TO JUNCTION BOX	208	150	1	1/0	N/A	#6	2"			
2	JUNCTION BOX TO DC-1	208	250	1	250 MCM	N/A	#4	2.5"			
3	DC-1 TO 1600A SWITCH	208	250	1	250 MCM	N/A	#4	2.5"			
		STAND	BY FEE	EDER S	CHEDULE 10-	17					
KEY	DESCRIPTION	VOLTAGE	AMPS	# SETS	CONDUCTOR SIZE	NEUTRAL SIZE	GROUND SIZE	EMT SIZE			
10	COGEN TO JUNCTION BOX	208	150	1	1/0	N/A	#6	2"			
11	JUNCTION BOX TO DC-2	208	200	1	3/0	N/A	#6	2"			
12	DC-2 TO XFER	208	200	1	3/0	N/A	#6	2"			
13	XFER TO ATS	208	200	1	3/0	3/0	#6	2"			

200

200

208 | 100 | 1

200 | 1

1

1

208

208

208

EQUIPMENT PROVIDED BY AEGIS:

(ALL MOUNTING, WIRING, SERVICE DISCONNECTS, AND TERMINATIONS BY ELECTRICIAN EXCEPT AS NOTED)

ATS TO DC-3

DC-3 TO 600A PANEL

ATS TO SBDP

SBDP TO SBDP-BR

14

15

16

17

(CHP-1 & CHP-2) COGENS (2) 35 KW YANMAR CP35D1 - SET BY AEGIS. ALL CONNECTIONS IN AREA OF COGEN SHOWN. SEPARATE POWER AND CONTROL CONDUITS. SEPERATE STANDBY AND NORMAL POWER CIRCUITS. ALL CONTROL WIRES CAN BE RUN IN THE SAME CONDUIT. INSTALL SUPPLEMENTARY #1/0 CHASSIS GROUND TO BUILDING STEEL OR EARTH GROUNDING ROD.

(HX-2) COGEN RADIATOR.

(CCP) COGEN CONTROL PANEL,

(TS-1,2,13) TEMPERATURE SENSORS FIELD INSTALLED BY PLUMBERS

(P-1,2) PUMPS INSTALLED ON PIPING ABOVE COGENS BY PLUMBER.

(F-1, F-2) Ceiling mounted fans. Install rheostat on wall NEAR UNIT, PROVIDED LOOSE WITH UNIT.

(GM) GAS METER INSTALLED BY PLUMBERS.

(MD-1) MOTORIZED DAMPER INSTALLED BY MECHANICAL CONTRACTOR. (V-1) 3 WAY VALVE PROVIDED BY AEGIS AND INSTALLED BY PLUMBER IN CEILING

(H8043) H8043 VERIS METER INSTALLED ON MAIN BUS DOWNSTREAM OF CONED CT'S FOR METERING BUILDING KW IMPORT & VOLTAGE

(H8035-1,2) INSTALL H8035-1 METER IN SBDP, H8035-2 IN DC-1

SUPPLIED, INSTALLED & TERMINATED BY ELECTRICIAN:

(DC-2) NEW 240VAC, 200 AMP RATED, HEAVY DUTY FUSED DISCONNECT WITH 200 AMP FUSES. VISIBLE BREAK, GANG OPERATED.

(XFMR) NEW 75 KVA, 208A TO 120/208Y TRANSFORMER. INSTALL GROUNDING ROD TO CHASSIS BUT DO NOT BOND TO NEUTRAL. INSTALL WITH DELTA CONNECTED TO THE GENERATOR AND WYE TOWARDS THE ATS. <u>DO NOT BOND NEUTRAL TO GROUND.</u>

(ATS) NEW 200A, 208VAC, 3 POLE ATS, ASCO 300 OR SIMILAR.

(SBDP) NEW 200A, 120/208V, 3 POLE DISTRIBUTION BOARD WITH 200A MAINS BREAKER. SEE SCHEDULE ON THIS SHEET.

(DC-3) NEW 200A, 208V RATED 3 POLE FUSED DISCONNECT WITH 200A FUSES. TAP FROM INCOMING FEEDERS ON EXISTING 800A DISTRIBUTION PANEL. CONNECT TO BOTH SETS OF INCOMING FEEDERS OR CONNECT TO SPARE LUG ON PANEL.

(DC-1) NEW 400A, 208V RATED 3 POLE FUSED DISCONNECT WITH 250A FUSES. TAP FROM INCOMING FEEDERS ON EXISTING 800A DISTRIBUTION PANEL. CONNECT TO BOTH SETS OF INCOMING FEEDERS OR CONNECT TO SPARE LUG ON PANEL. INSTALL 8035-300 POWER METER SUPPLIED BY AEGIS ON LOAD SIDE OF DISCONNECT FOR COGEN POWER MEASUREMENT.

(ESTOP) NEW BREAK GLASS STATION FOR COGENS, 2 SETS OF PILOT CONTACTS.

<u>NOTES:</u> (1 ONLY)

(1) RE-FEED EXISTING 100A BOILER PANEL FROM SBDP.

- * USE 3/4" EMT MINIMUM FOR ALL RUNS, SEPARATE CONTROL AND LINE VOLTAGE WIRE.
- * PROVIDED BY OWNER, 1) CAT5 COMMUNICATIONS LINE FOR CCP PANEL, WITH (1) DEDICATED STATIC IP.
- * ELECTRICAL SUBCONTRACTOR IS RESPONSIBLE FOR FIRESTOPPING ALL PENETRATIONS. ALL FIRE STOPPING SHALL USE APPROVED SYSTEMS AND METHODS AND SHALL MEET OR EXCEED 2 HR RATING.

NEW SBDP 200A MAIN CIRCUIT BREAKER PANEL SCHEDULE VOLTAGE: 120/208V 34 4W

	1							
CIRCUIT DESC.	TRIP AMPS		۲	В	С		TRIP AMPS	CIRCUIT DES
		1		•		2		
MAIN FUSE	200A	3			•	4	100A	BOILERS
		5	٠			6		
		7		•		8		
CCP	30A	9				10	X	SPARE
		11				12		
GFCI	20A	13				14	Х	SPARE
SPARE	Х	15				16	Х	SPARE
SPARE	X	17				18	Х	SPARE

	TRANSFORMER SCHEDULE								
KEY	SIZE	PHASE		PRIMARY					
NET	SIZE	PHASE	TYPE	VOLTS	SETS	CONDUCTOR	NEUTRAL	GROUND	CONDUIT
			DELTA	208	1	3/0	N/A	#6	2"
XFMER	75kVA	3		SECONDARY					
			WYE	208	1	3/0	3/0	#6	2"

<u>Power runs:</u> (10–15) <100A

- (10) FROM CCP TO SBDP (4) #10 W/ SS (30A)
- (1) (2 PLACES) FROM PUMP TO CCP P-1,2 - (2) #12 W/GND & SS (15A)

3/0

3/0

3/0

#3

3/0

3/0

3/0

#3

#6

#6

#6

#8

2"

2"

2"

1.25"

- (2 PLACES) FROM FAN TO CCP F-1,2 - (2) #10 W/GND & SS (20A)
- (13) FROM HX-2 TO CCP RADIATOR (3) #12 W/GND & 3P NEMA3R SS (15A)
- (14) FROM LM-1 TO SBDP GFCI (2) #12 W/ GND. (20A)
- (15) FROM LM-1 TO CCP
- P-3,4 (3) #12 W/GND & SS (15A)
- <u>CONTROLS:</u> (20–27)
- (20) (2 PLACES) FROM CHP-1/2 TO CCP (10) #18/2 SHIELDED, WIRING NOTES BELOW (1) CAT5e SHIELDED
- (21) (2 PLACES) FROM TS-1,2 TO CCP (1) #18/2 SHLD
- - (1) #18 SHIELDED
- (1) #18/2 SHIELDED
- 24) FROM HX-2 TO CCP
- (1) #18/2 SHIELDED

- (2) #18 THHN W/ SERVICE SW (1) #18 SHIELDED

PERFORMANCE MONITORING: (35-37)

- (35) FROM GAS METER TO CCP GAS PULSE (1) 18/2 SHIELDED
- (36) DAISY CHAIN #1 DC-1 TO SBDP
- (1) 18/2 SHLD SBDP TO LM-1 (BTU)
- (1) 18/2 SHLD
- LM-1 (BTU) TO CCP (1) 18/2 SHLD
- (37) daisy chain #2 H8043 (MAINS) TO CHP-1 (1) 18/2 SHLD CHP-1 TO CHP-2
- (1) 18/2 SHLD CHP-2 TO CCP
- (1) 18/2 SHLD (38) From LM-1 (BTU) to CCP
- (1) #18/2 SHLD (24V POWER)
- (39) FROM H8035-1 TO CCP PARASITIC POWER (1) 18/2 TWISTED SHIELDED
- (40) FROM H8035-2 TO CCP COGEN POWER (1) 18/2 TWISTED SHIELDED

COGEN INTERLOCK: (45)

(45) FROM CHP-1 TO CHP-2 (2) 18/2 SHIELDED (4) 18/3 SHIELDED

LN

KEY MODEL VOLTAGE AMPS NORMAL

ATS ASCO 300 208 200


(22) FROM LM-1 TO CCP TS-3,11,12 (6) #18/2 SHIELDED V-2 (2) #18 THHN W/ SERVICE SW

\bigcirc					
(23)	FROM	HWT-1	ΤO	ССР	
\bigcirc	TS-í	13			

- TS-21

- (1) #18/2 SHLD (POWER) (1) #18/2 SHLD (STATUS)
- (26) FROM V-1 TO CCP
- (2) #18/2 SHLD
- (25) FROM MD-1 TO CCP

 - (27) FROM ESTOP TO CCP

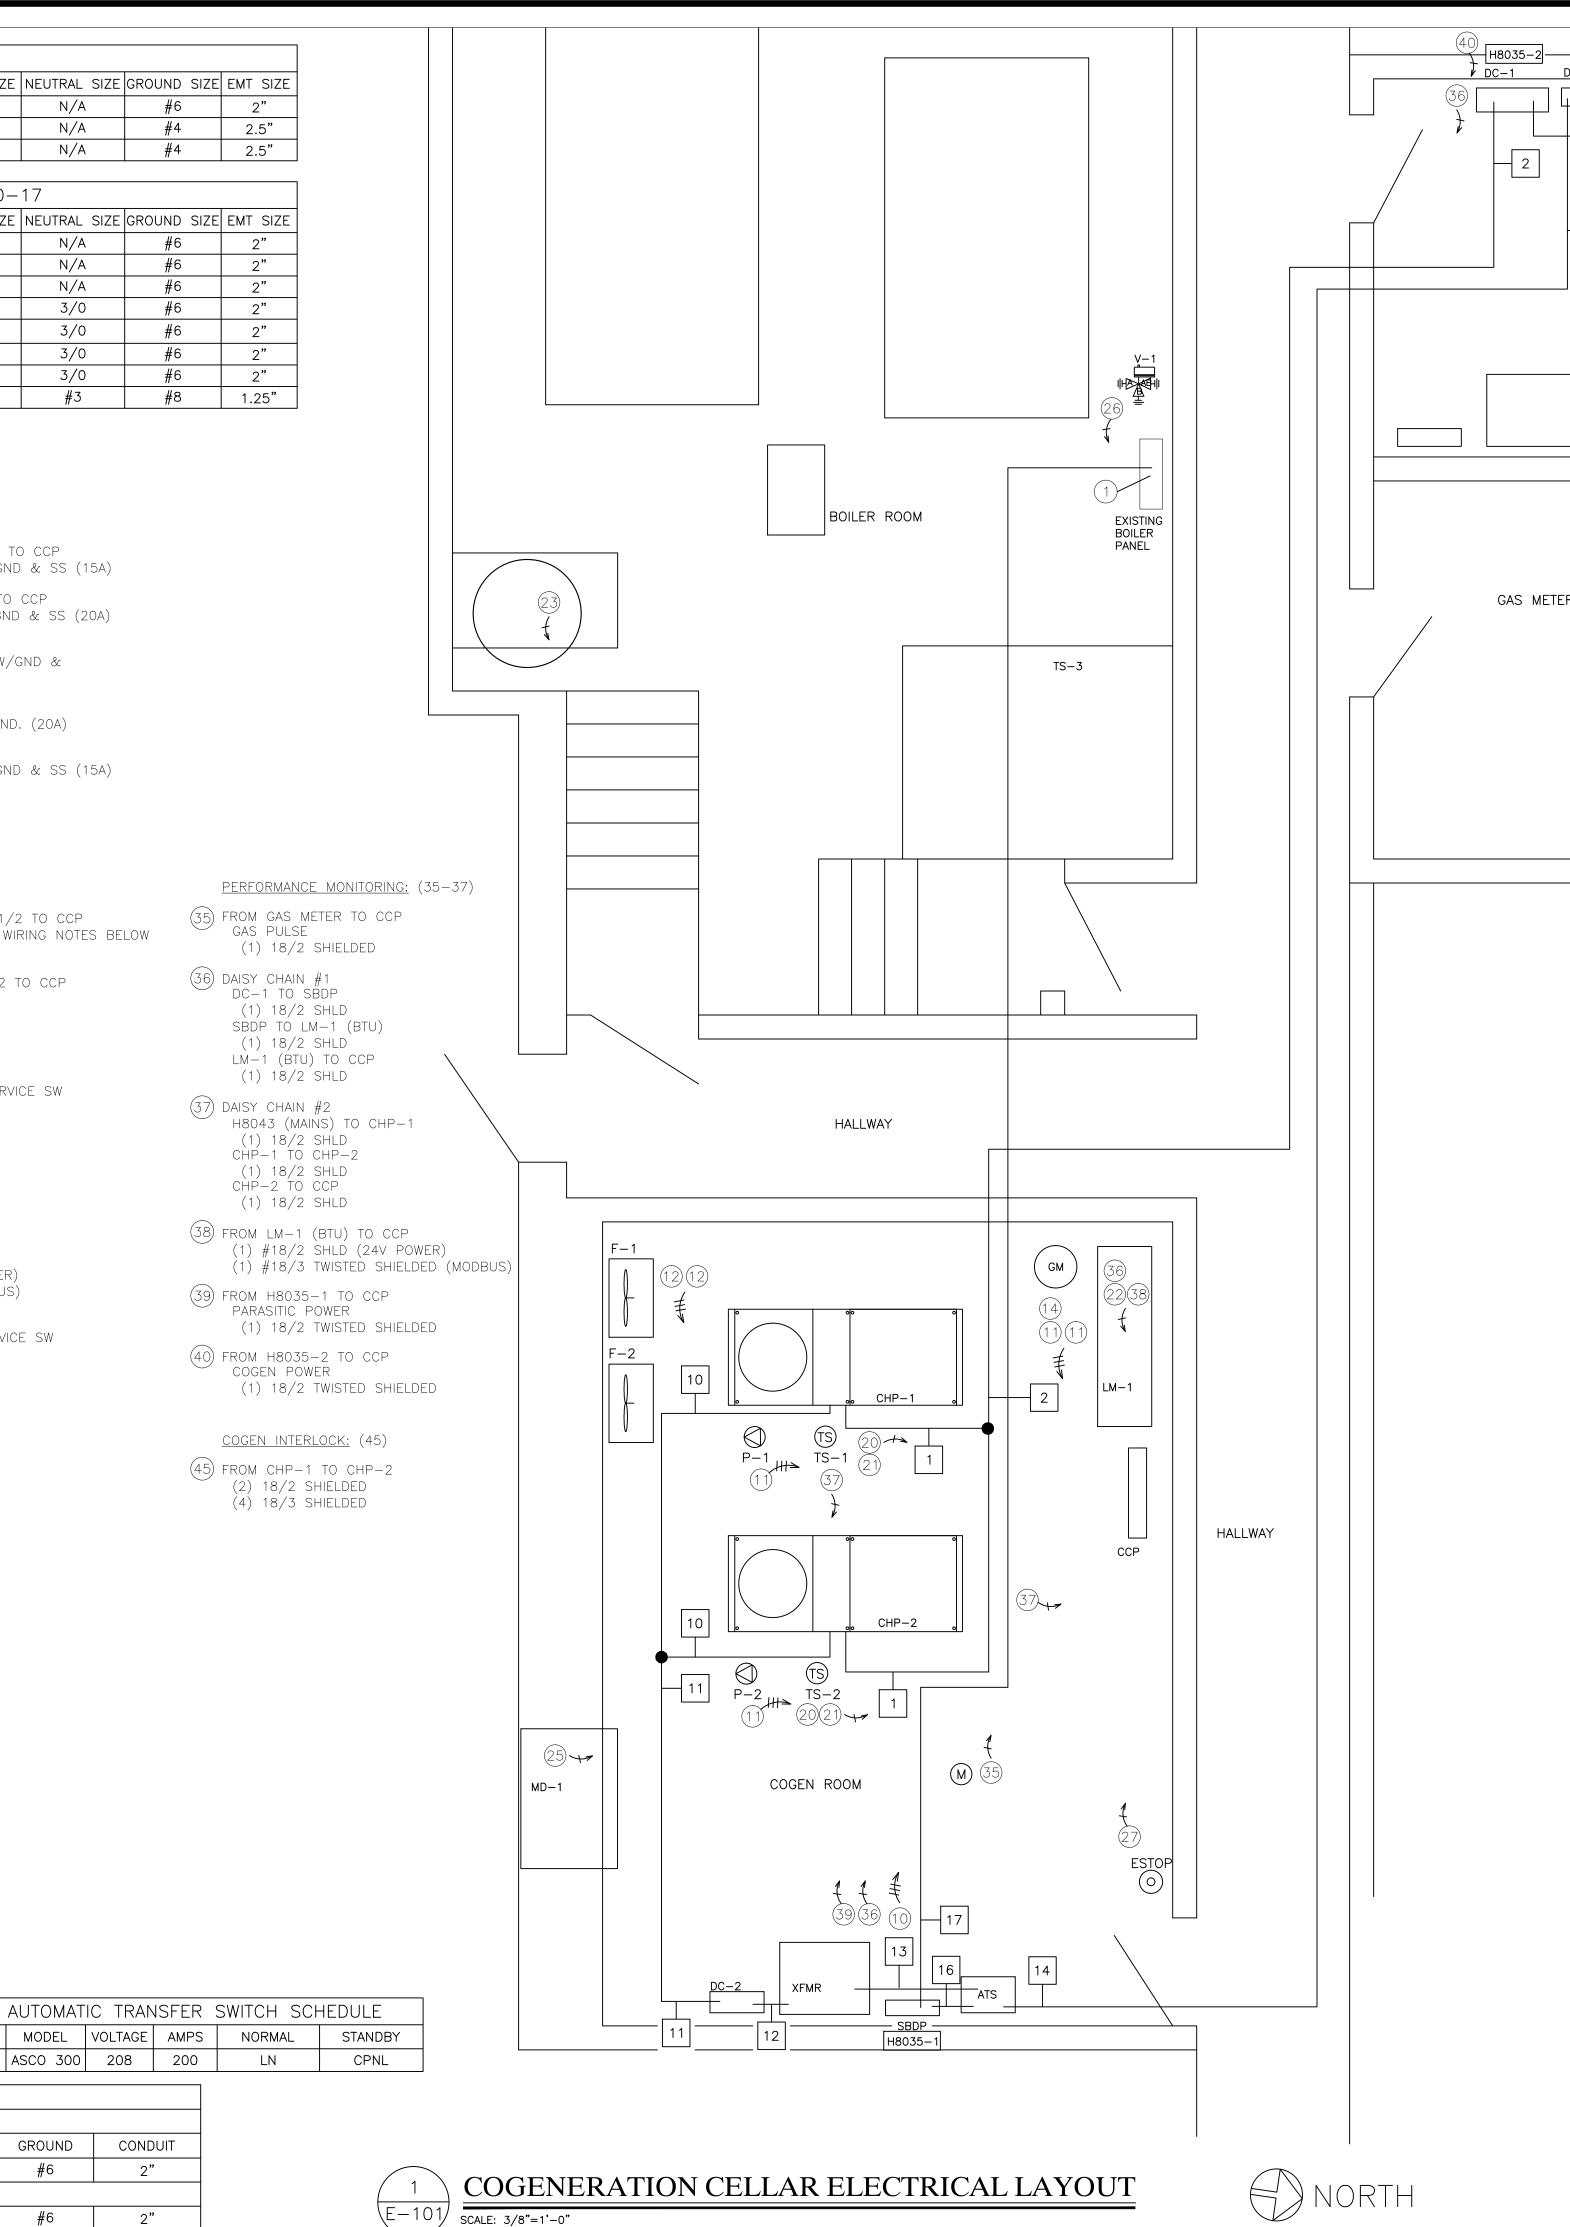

			NO.	DATE	REVISION DESCRIPTION
DC-3					
14 ELECTRIC ROOM ← 37 H8043				LOIT AVE	WORK NE NEN LOIS NE
R ROOM			CLIENT AEGI 55 C HOL`	TRUE NORTH S ENERGY JACKSON S YOKE, MA	01040
	(24) ↓ (TS) TS-21		FAX: ATTN AL BL STATE IT IS UNLES LICEN	E READ <u>MENT:</u> A VIOLATION SS ACTING UN ISED ENGINEEI	-1104
STORAGE	13 GFI	HX-2	BEARI IS AL SHALI NOTA SIGNA ALON ALTEF PROP THE F INTEN AS A BETWI AND COPY REUS	ING THE SEAL TERED, THE A _ AFFIX TO TH TION "ALTERED TURE AND TH G WITH A SPE RATION ON TH <u>RIETARY STATH</u> PLANS AND SF DED FOR THE RESULT OF (EEN BECKER SPECIFICATION RIGHT PETITIO ED BY ANYON	OF AN ENGINEER/ARCHITECT ALTERING ENGINEER/ARCHITECT HIS ITEM THEIR SEAL AND THE D BY", FOLLOWED BY HIS/HER HE DATE OF SUCH ALTERATION, ECIFIC DESCRIPTION OF THE HE DRAWING.
			BE 77 LY PH FA SU	7 SUNRISE NBROOK, N IONE: (5	16) 561—5922 323—0219 EMAIL: EPC.US
			PROJE	PLAZA COGENER	RESIDENCES RATION PROJECT
			C	BROOKL NG TITLE: ELLAR	EW LOTS AVE YN, NY 11212 ELECTRICAL LAYOUT
			DRN E CKD E FINAL SCALE: DWG N	BY: CKD BY: AS NOTED NO.	PAGE 8 OF 9
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